

# **Amendment of Solicitation**

Date of Issuance: 12/12/2025	Solici	tation No.	3450035790	
Requisition No. 26-FM-0014	Amen	dment No.	1	
Hour and date specified for receipt of offers is ch	anged: 🛚 No	☐ Yes, to:	C	ST
Pursuant to OAC 260:115-7-30(d), this document identified above. Such notice is being provided to Suppliers submitting bids or quotations shall acknowled and date specified in the solicitation as follows: Sign and return a copy of this amendment with the supplier has already submitted a response, solicitation deadline. All amendment acknowledge bid opening date in the subject line of the email.	o all suppliers to who nowledge receipt on the solicitation respondant this acknowledger	ich the origi f this solicita onse being s nent must b	nal solicitation was sent.  Ition amendment <u>prior</u> to the hour  ubmitted; or, e signed and returned prior to the	d
ISSUED FROM:				
Heather Osborne 405-420-22	293	hosbor	ne@odot.org	
Contracting Officer Phone Nur	mber	E-Mai	il Address	
RETURN TO: odotbids@odot.ok.gov  Description of Amendment:				
a. This is to incorporate the following:				$\neg$
Amendment 1 covers:				
Questions & Reponses Sign-In Sheet – Non-mandatory Site Visit/Pre-Bi Plan-holder's List Corrected Cover Sheet Updated Index & Missing Sheets Pay Item Sheet (Excel)	id			
Interested Contractors should complete Section	b and include this f	orm with the	eir responses.	
b. All other terms and conditions remain unchang	ged.			
Supplier Company Name (PRINT)		Da	ate	
Authorized Representative Name (PRINT) Fitl	e		uthorized Representative Signature	

### **QUESTIONS AND ANSWERS**

Q 1: Are these buildings going to be PEMB or are they brick & mortar, stick-built buildings?

A 1: PEMB

Q 2: Can you share the Bid Form for the Brayn County ODOT project in Excel?

A 2: Yes, ODOT will provide with Amendment 1.

Q 3: Is US Steel required?

A 3: No

Q 4: Is this project sales tax exempt?

A 4: ODOT is tax-exempt. This tax-exempt status <u>does not</u> pass on to contractors, subcontractors, or their suppliers.

Q 5: The following sheets are missing from the set. Please provide. (MA6.1, MA12.0, MA7.0, MA8.0, MA11.0)

A 5: Index to be updated, and any missing sheets will be added.

Q 6: These sheets are missing from the index. Contractors often don't know they are there when searching for information, or they may not be aware of their connection. Please provide. (C3.4, MA5.1&2, MA9.1, MA9.1, MA10.0,1,2, &3. MA11.2 &3, MA12.0 & 1, MA7.0 & 8)

A 6: Index to be updated, and any missing sheets will be added.

Q 7: This is listed twice. Please clarify. (WS3.0)

A 7: Index to be updated, and any missing sheets will be added.

Q 8: Dimensions indicate a 10,000-sf pond. The pond notes indicate a surface area of 3,600 square feet. Please clarify. (C8.0)

A 8: Pond is 10,000 sf. C8.0 detail will be updated to correct pond information.

Q 9: What is the surface under the two propane tanks? (C3.0)

A 9: Contractor provides and installs tanks with an adequate concrete foundation.

Q 10: What is the surface area surrounding the Aerobic Spray Field as shown? (C3.0)

A 10: Grass/Sod

Q 11: Where are the sod/turf areas? Plans and specs are very vague. (C3.0)

A 11: All disturbed areas that are not noted as paving will be required to be seeded or sodded.

Q 12: Please provide more information on the Aerobic Treatment System. (C5.4)

A 12: The aerobic treatment system shall meet the requirements set forth in the soil profile test and the on-site sewage treatment OKDEQ application. Manufacturer to meet these standards.

Q 13: Please provide more information on the Water Well. (C5.1)

A 13: Water well sub-contractor to provide a system that meets demand and ODEQ requirements.

Q 14: Please provide more information for the CORS/SCIGN Unit. (C10.8)

A 14: All information has been provided.

Q 15: Are the millings provided by ODOT and delivered to the site?

A 15: Yes, provided by ODOT, placed by the contractor.

Q 16: Please provide details for the pad and footing beneath the propane tanks. (C5.1)

A 16: Contractor to provide and install tanks with adequate concrete foundations.

Q 17: Is the contractor responsible for the pad design at the fuel tank? (C6.0)

A 17: See Sheet C6.0 Pad is 8" thick PC Concrete with #4 bars at 12" OC. See details on 10.7.

Q 18: Who is responsible for the cost of special inspections? (S2.0)

A 18: Any special inspections are the responsibility of the contractor.

Q 19: Please clarify if the contractor provides the light pole or ODOT (C5.0).

A 19: Contractor provides the poles.

Q 20: Please indicate the location of the blinds to be installed. (MA10.0)

A 20: Roller shades to be installed at X2 and W1 windows, refer to floor plan for window locations.

Q 21: Who provides the equipment from Grainger? (MA10.3)

A 21: This is the contractor's responsibility.

Q 22: Details show 2 different layers of insulation. Normal practice is a one (1) layer of vinyl-backed insulation, determined by the gurt depth. Please clarify. (MA11.2-3)

A 22: One layer is intended to be dedicated PEMB insulation, and the other is a part of the simplesaver. Some assemblies from manufacturers use two layers. However, follow the manufacturer's instructions, as per specifications, and meet the R-value requirements and total thickness. If the manufacturer requires one layer of insulation that meets the R-value and thickness requirements, as well as other specifications, it is acceptable.

Q 23: Note states a "MONITORED FIRE ALARM REQUIRED AND IS PROVIDED." There are no FA plans for the building, and who is providing? Please clarify. (EA1.0)

A 23: This is the contractor's responsibility.

Q 24: If this is a firewall as noted, should there be fire caulking instead of joint sealer and backer rod? Please clarify. (EA3.0/10)

A 24: Provide fire caulking at fire-rated partitions.

Q 25: The Plan denotes that there are two shop bays, but the plans show only one bay. Please clarify. (EM1.0).

A 25: Sheets EM1.0 and EP1.0 are being replaced. Two shop bays is what is needed for this project.

Q 26: Are we allowed to burn on-site materials?

A 26: With approval from the Fire Marshal.

Q 27: The bid sheet, Exhibit A, shows each building with a total. Are we to include the building pad and utilities under it or just the slab and up? Please clarify.

A 27: Electrical and building pad to be included with each building.

Q 28: RFQ states 365 days for construction. When will the project commence?

A 28: NTP will be issued once a contract is in place. ODOT anticipates contract will be awarded by early February 2026.

Q 29: The drawings indicate a vent on the salt and mix shed, but it's not called out in the specs. Is it a mesh vent with no steel frame, a mesh vent with a steel frame, or a fixed louver vent? What size is required?

A 29: Mesh vent size & requirements are to be designed by manufacturer. No framing or steel intended to be used.

Q 30: Just a reminder that the Cover Page of the Specifications shows "DISTRICT 3, HUGHES/OKFUSKEE COUNTY, OKLAHOMA."

A 30: Cover Sheet has been corrected and attached.

Q 31: Question regarding the size and spacing of the rebar for the concrete paving areas.

A 31: The site concrete paving details are on sheet C10.0, details 3 and 4. This concrete is unreinforced. The concrete area at the fueling canopy is listed on sheet C6.0 as 8" thick PC concrete with #4 bars at 12 inches on center and refers to the detail shown on 10.7. If this does not clarify the paving parameters, please let me know.

Q 32: Shows 10 bays for the hopper rack and 11 catwalks. Is this correct? (HS2.0)

A 32: Yes, comply with the drawings.

Q 33: Will a 3/8" clevis-style hook be acceptable with the chains for the hopper rack? (HS2.0/3)

A 33: Yes

Q 34: Who is Responsible for Purchasing/Installing the Propane Tanks

A 34: This is the contractor's responsibility.

Q 35: Who is Responsible for purchasing and installing the Water Well? No Information on Bid Documents

A 35: This is the contractor's responsibility.

Q 36: Who is Responsible for Purchasing the Equipment and FF&E on Plan Sheet MA10.3

A 36: This is the contractor's responsibility.

Q 37: The Plans Show a Septic System and an Aerobic System, which System is to be used?

A 37: An aerobic system

Q 38: Please Confirm Who is Paying for the Project Materials Testing.

A 38: This is the contractor's responsibility.

Q 39: Please Confirm if the General Contractor and Subcontractors are Responsible for Sales Tax on Materials.

A 39: Yes, both are responsible for sales tax on materials.

Q 40: Who is responsible for establishing utilities, ie gas, water and electric and associated fees. **A 40: This is the contractor's responsibility.** 

graduate and the state of the s		11/19/202	
Brian County 1	Combined Pre bid	26-FM-001 J.P. NO.:	
COUNTY:	PROJ NO.:	J.P. NO.:	DATE:
DESCRIPTION:			SHT. OF
CALCULATED BY:	DATE:	CHECKED 8Y:	DATE:
Scott GRAVES	ODOT	sgreves@odot.ovo	HUS 9021 40
Wyatt Lopp		Wyaft@LappCenstduction.	,
Larry Lawson	Lopp Construction Dozer work Inc.	Dozerwork INC Com	
Kirk Harris	& Macco Boildes	Kharriseme	accibuilders.con
Jason Magnerson	W.L. Mc Narialo	Jason@WLMenai	620-210-1196 Tum
Redwit	Prazza Construction, L	KC rodopiazzanc	sostenctin any
Pien Myors	Cordeck ric	k. myers a cordeck	703-463-2384
Isáac Land	JAL Construction	office War construction 1 405.288-9	LLICON
& Brandon Sexton	flying G Ag solution		g on ag soludions.com

# Solicitation # 3450035790

## Planholder's List

Company Name	Contact Name	Phone #	Email Address	City/State/Zip	Sent
MacCo Builders	Matt McConnell	417-499-8450	mmcconnell@maccobuilders.com	Joplin, MO	х
Lopp Construction	Wyatt Lopp	405-466-9259	Wyatt@loppconstruction.com	Stillwater, OK	х
McNatt & Company	Jason Masterson	405-232-7245	Jason@wlmcnatt.com	OKC, OK 73131	х
Hoey Construction	Philip Goddard	918-277-3390	pgoddard@hoeyconstruction.com	Tulsa, OK 74107	х
Piazza Construction	Chuck Walsh	903-463-2384	chuck@piazza-construction.com	Dennison, TX 75020	х
Mid-Plains Construction	Stacy Wilson	580-924-0288	mpc@midplainsinc.com	Durant, OK 74701	Х
Pillar Contracting	Cole Travis	405-818-3075	ctravis@pillarcontracting.com	OKC, OK 73132	х
Timberlake Construction	Walter Edge	918-927-1585	walter.edge@timberlakeconstruction.com	Tulsa, OK	х
ePlan Bidding	John Nall	573-447-7130	eplan@eplanbidding.com	Columbia, MO	х
Miller-Tippens Construction	Michael Phillips	405-613-5326	michaelp@miller-tippens.com	OKC, OK 73105	х
Treas Construction	James Schreiber		james@treasconstruction.com		Х
Ascend Commercial Buildings	Kyle Jackson	918-260-4755	Kyle@ascendok.com	Tulsa, OK 74105	Х
Adept Patriot Services	Emily Snyder	918-728-0063	esnyder@adeptpatriotservices.com		х
JNL Construction	Kylie Nelson	405-757-8054	kylie@jnlconstructionllc.com	OKC, OK 73116	X

# Bryan County Combined Maintenance Yard

# *Solicitation # 3450035790*

AC Owen Construction	Maria Spadaccini	802-922-4218	maria@ac-owen.com	Edmond, OK 73003	х
Hoidale Inc (S)	Craig Quigley	405-495-7010	cquigley@hoidale.com	OKC, OK 73127	х
Seaton Construction	Eric Gilman	316-644-7208	egilman@seaton-construction.com	Wichita, OK 67209	х
Timberlake Construction	Walter Edge	918-927-1585	walter.edge@timberlakeconstruction.com	Tulsa, OK	Х
Third Generation Electric (S)	April Price	918-504-5394	april@tgetulsa.com	Tulsa, OK 74132	х
Downey Contracting LLC	Day Zimbelman	405-478-5277	dzimbelman@downeycontracting.com		х
Premier Lighting Sales (S)	Jennifer Rozene	918-669-9008	jrozene@plsok.com		Х

P = Prime Contractor S = Subcontractor

# SPECIFICATIONS AND CONTRACT DOCUMENTS

# BRYAN COUNTY MAINTENANCE FACILITY

OKLAHOMA DEPARTMENT OF TRANSPORTATION DISTRICT 2, BRYAN COUNTY DURANT, OKLAHOMA

> J/P NO. 32504(04) PROJECT NO. BSAP-207E(121)FM

> > August 8, 2025



CEC Corporation www.connectcec.com OK CA# 32 Exp: 2026-06-30

# STATE OF OKLAHOMA DEPARTMENT OF TRANSPORTATION

PLAN OF PROPOSED

# BRYAN COUNTY MAINTENANCE FACILITY ^ DURANT, OKLAHOMA DISTRICT II

J/P No.: 36540 (04) PROJECT No.: BSAP-207E(121)FM





STATE MAP

N.T.S.

# EAKER FIELD \ **PROJECT** SITE

PROJECT LOCATION MAP

ALL CONSTRUCTION SHALL BE IN ACCORDANCE WITH THE OKLAHOMA DEPARTMENT OF TRANSPORTATION 2019 STANDARD SPECIFICATIONS FOR HIGHWAY CONSTRUCTION AND SPECIAL PROVISIONS. PROJECT SPECIFICATIONS GOVERN OVER STANDARD SPECIFICATIONS.

# SHEET INDEX

# CIVIL

C0.0 - TITLE SHEET

1 - SURVEY SHEET

C0.1 - NOTES & LEGEND

C2.0 - OVERALL DEMOLITION PLAN

C3.0 - OVERALL SITE PLAN

C3.1 - SITE PLAN

C3.2 - SITE PLAN C3:3 SIVE PLAN

C3.4 - SITE PLAN

C4.0 - OVERALL GRADING PLAN

C4.1 - GRADING PLAN

C4.2 - GRADING PLAN C4.3 - GRADING PLAN

C4.4 - GRADING PLAN

C4.5 - STORM GRADING PLAN

C4.6 - STORM GRADING PLAN

C4.7 - ENTRANCE DRIVE GRADING

C5.0 - OVERALL UTILITY PLAN

C5.1 - UTILITY PLAN

C5.2 - UTILITY PLAN

C5.3 - UTILITY PLAN

C5.4 - UTILITY PLAN

C6.0 - FUELING PLAN

C7.0 - SEPTIC DETAILS

**C8.0 - EVAPORATION POND DETAILS** 

C9.0 - OVERALL EROSION PLAN

C10.0 - DETAILS

C10.1 - DETAILS

C10.2 - DETAILS

C10.3 - BRINE TANK PAD DETAILS

C10.4 - FENCE DETAILS

C10.5 - UTILITY DETAILS

C10.6 - FLEXAMAT DETAILS

C10.7 - HERBICIDE TANK PAD DETAILS C10.8 - CORS TOWER DETAILS

# **GENERAL**

S1.0 - STRUCTURAL GENERAL NOTES

S2.0 - STRUCTURAL SPECIAL INSPECTIONS &

ABBREVIATIONS

S3.0 - STRUCTURAL TYPICAL DETAILS

M1.0 - MECHANICAL LEGEND & NOTES

M2.0 - MECHANICAL DETAILS

E1.0 - ELECTRICAL COVER SHEET

E2.0 - ELECTRICAL ONE-LINE DIAGRAM &

SCHEDULES

E3.0 - ELECTRICAL SITE PLAN

E4.0 - ELECTRICAL DETAILS

P1.0 - PLUMBING LEGEND & NOTES

P2.0 - PLUMBING DETAILS

# MAINTENANCE BUILDING

MA1.0 - CODE ANALYSIS

MA2.0 - FLOOR PLAN

MA3.0 - ROOF PLAN

MA4.0 - EXTERIOR ELEVATIONS MA5.0 - BUILDING SECTIONS

MA5.1 - WALL SECTIONS

MA5.2 - WALL SECTIONS

MA6.0 - SECTION DETAILS MA9.0 - ENLARGED PLANS & DETAILS

MA9.1 - ENLARGED PLANS & DETAILS

MA10.0 - ROOM FINISH SCHEDULE

MA10.1 - FINISH PLAN

MA10.2 - INTERIOR ELEVATIONS

MA10.3 - FFE FLOOR PLAN

MA11.1 - DOOR SCHEDULE & DETAILS

MA11.2 - DOOR & WINDOW DETAILS

MA11.3 - DOOR & WINDOW DETAILS

MA12.1 - REFLECTED CEILING PLAN

MS1.0 - MAINTENANCE FOUNDATION PLAN

MS2.0 - MAINTENANCE DESIGN CRITERIA & DETAILS

MM1.0 - MAINTENANCE MECHANICAL PLAN

MM2.0 - MAINTENANCE MECHANICAL SCHEDULES

MAINTENANCE BUILDING

ME0.1 - MAINTENANCE PANEL SCHEDULES ME1.0 - MAINTENANCE LIGHTING PLAN

ME2.1 - MAINTENANCE POWER PLAN

ME3.1 - MAINTENANCE SYSTEMS PLAN

MP1.0 - MAINTENANCE PLUMBING PLANS MP1.1 - MAINTENANCE WASTE/VENT PLANS

MP2.0 - MAINTENANCE PLUMBING SCHEDULES

# **EQUIPMENT SHED - SHOP BAY**

EA1.0 - FLOOR PLAN

EA2.0 - ELEVATIONS & SECTIONS

EA3.0 - DETAILS

ES1.0 - SHOP SHED FOUNDATION PLAN

ES2.0 - SHOP SHED FOUNDATION DETAILS

ES3.0 - SHOP SHED HOIST DETAIL

EM1.0 - SHOP SHED MECHANICAL PLAN

EE1.0 - SHOP SHED LIGHTING PLAN

EE2.0 - SHOP SHED POWER & SYSTEMS PLAN EP1.0 - SHOP SHED PLUMBING PLANS

### **EQUIPMENT SHED - WASH BAY**

WA1.0 - FLOOR PLAN

WA2.0 - ELEVATIONS & SECTIONS

WA3.0 - DETAILS

WS1.0 - WASH SHED FOUNDATION PLAN

WS2.0 - WASH SHED FOUNDATION DETAILS WS3.0 - WASH SHED CATWALK DETAILS

WM1.0 - WASH SHED MECHANICAL PLAN

WE1.0 - WASH SHED LIGHTING PLAN

WE2.0 - WASH SHED POWER & SYSTEMS PLAN WP1.0 - WASH SHED PLUMBING PLANS

HOPPER RACK HA2.0 - HOPPER RACK

HA2.1 - DETAILS

HS1.0 - HOPPER RACK FOUNDATION PLAN

HS2.0 - HOPPER RACK FRAMING PLAN & ELEVATIONS

HS3.0 - HOPPER RACK DESIGN CRITERIA &

FOUNDATION DETAILS

HS4.0 - HOPPER RACK CATWALK DETAILS

**FUEL CANOPY** FA2.0 - FUEL CANOPY

FS1.0 - FUEL CANOPY FRAMING PLAN

FS2.0 - FUEL CANOPY DETAILS

# **ODOT STANDARDS**

SECTIONS

PCES-5-1 - PREFABRICATED CULVERT END

SPI-5-2 - STANDARD PIPE INSTALLATION

PBB-1-2 - PIPE BEDDING & BACKFILL

RWF3-3-2 - RIGHT-OF-WAY FENCE STYLE CLF

(CHAINLINK FENCE)

Oklahoma.

Note: These drawings and related design calculations were performed solely for the construction of the ODOT District 2 Bryan County Maintenance Facility in Durant,

The layout and design shown is not intended to be utilized at any other site without site adaptation by the Engineer and Architectural firm responsible for its original design.



CEC CORPORATION WWW.CONNECTCEC.COM OK CA#: 32 EXP.: 2026-06-30 CEC PROJECT #240622



### **REVISION SUMMARY – ADDENDUM #01**

**Project:** ODOT Maintenance Facility and Residency, District 2 – Bryan County

**Project No.:** 240622

**Revision Date:** December 10, 2025

This summary is provided for the sole purpose of assisting the project team in understanding the revisions to the Contract Documents made by CEC. In no way is this to be considered an exhaustive list. The contractor shall remain responsible for reviewing and conforming to the Contract Documents.

### **MODIFICATIONS TO DRAWINGS:**

### **CIVIL**

SHEET Title Sheet

- 1. ADDED C3.4 TO CIVIL INDEX
- 2. UPDATED MAINTENANCE BUILDING SHEET LIST

SHEET C3.1

1. UPDATED NOTE FOR PROPANE TANK AREA.

SHEET C5.0

- 1. REMOVED NOTES ABOUT USING ATTIC STOCK FOR LIGHT POLES SHEET  $\mathsf{C8.0}$
- 2. UPDATED DESIGN NOTES FOR EVAPORATION POND.

### <u>MEP</u>

SHEET WM1.0

3. TITLE BLOCK CHANGE.

SHEET WP1.0

1. SANITARY BUILDING EXIT FLIPPED, TITLE BLOCK CHANGED.

SHEET EM1.0

1. SINGLE BAY TO DOUBLE BAY SHOP SHED, TITLE BLOCK CHANGED.


SHEET EP1.0


1. SINGLE BAY TO DOUBLE BAY SHOP SHED, TITLE BLOCK CHANGED.

### **MODIFICATIONS TO SPECIFICATIONS:**


None

### **END OF SUMMARY**

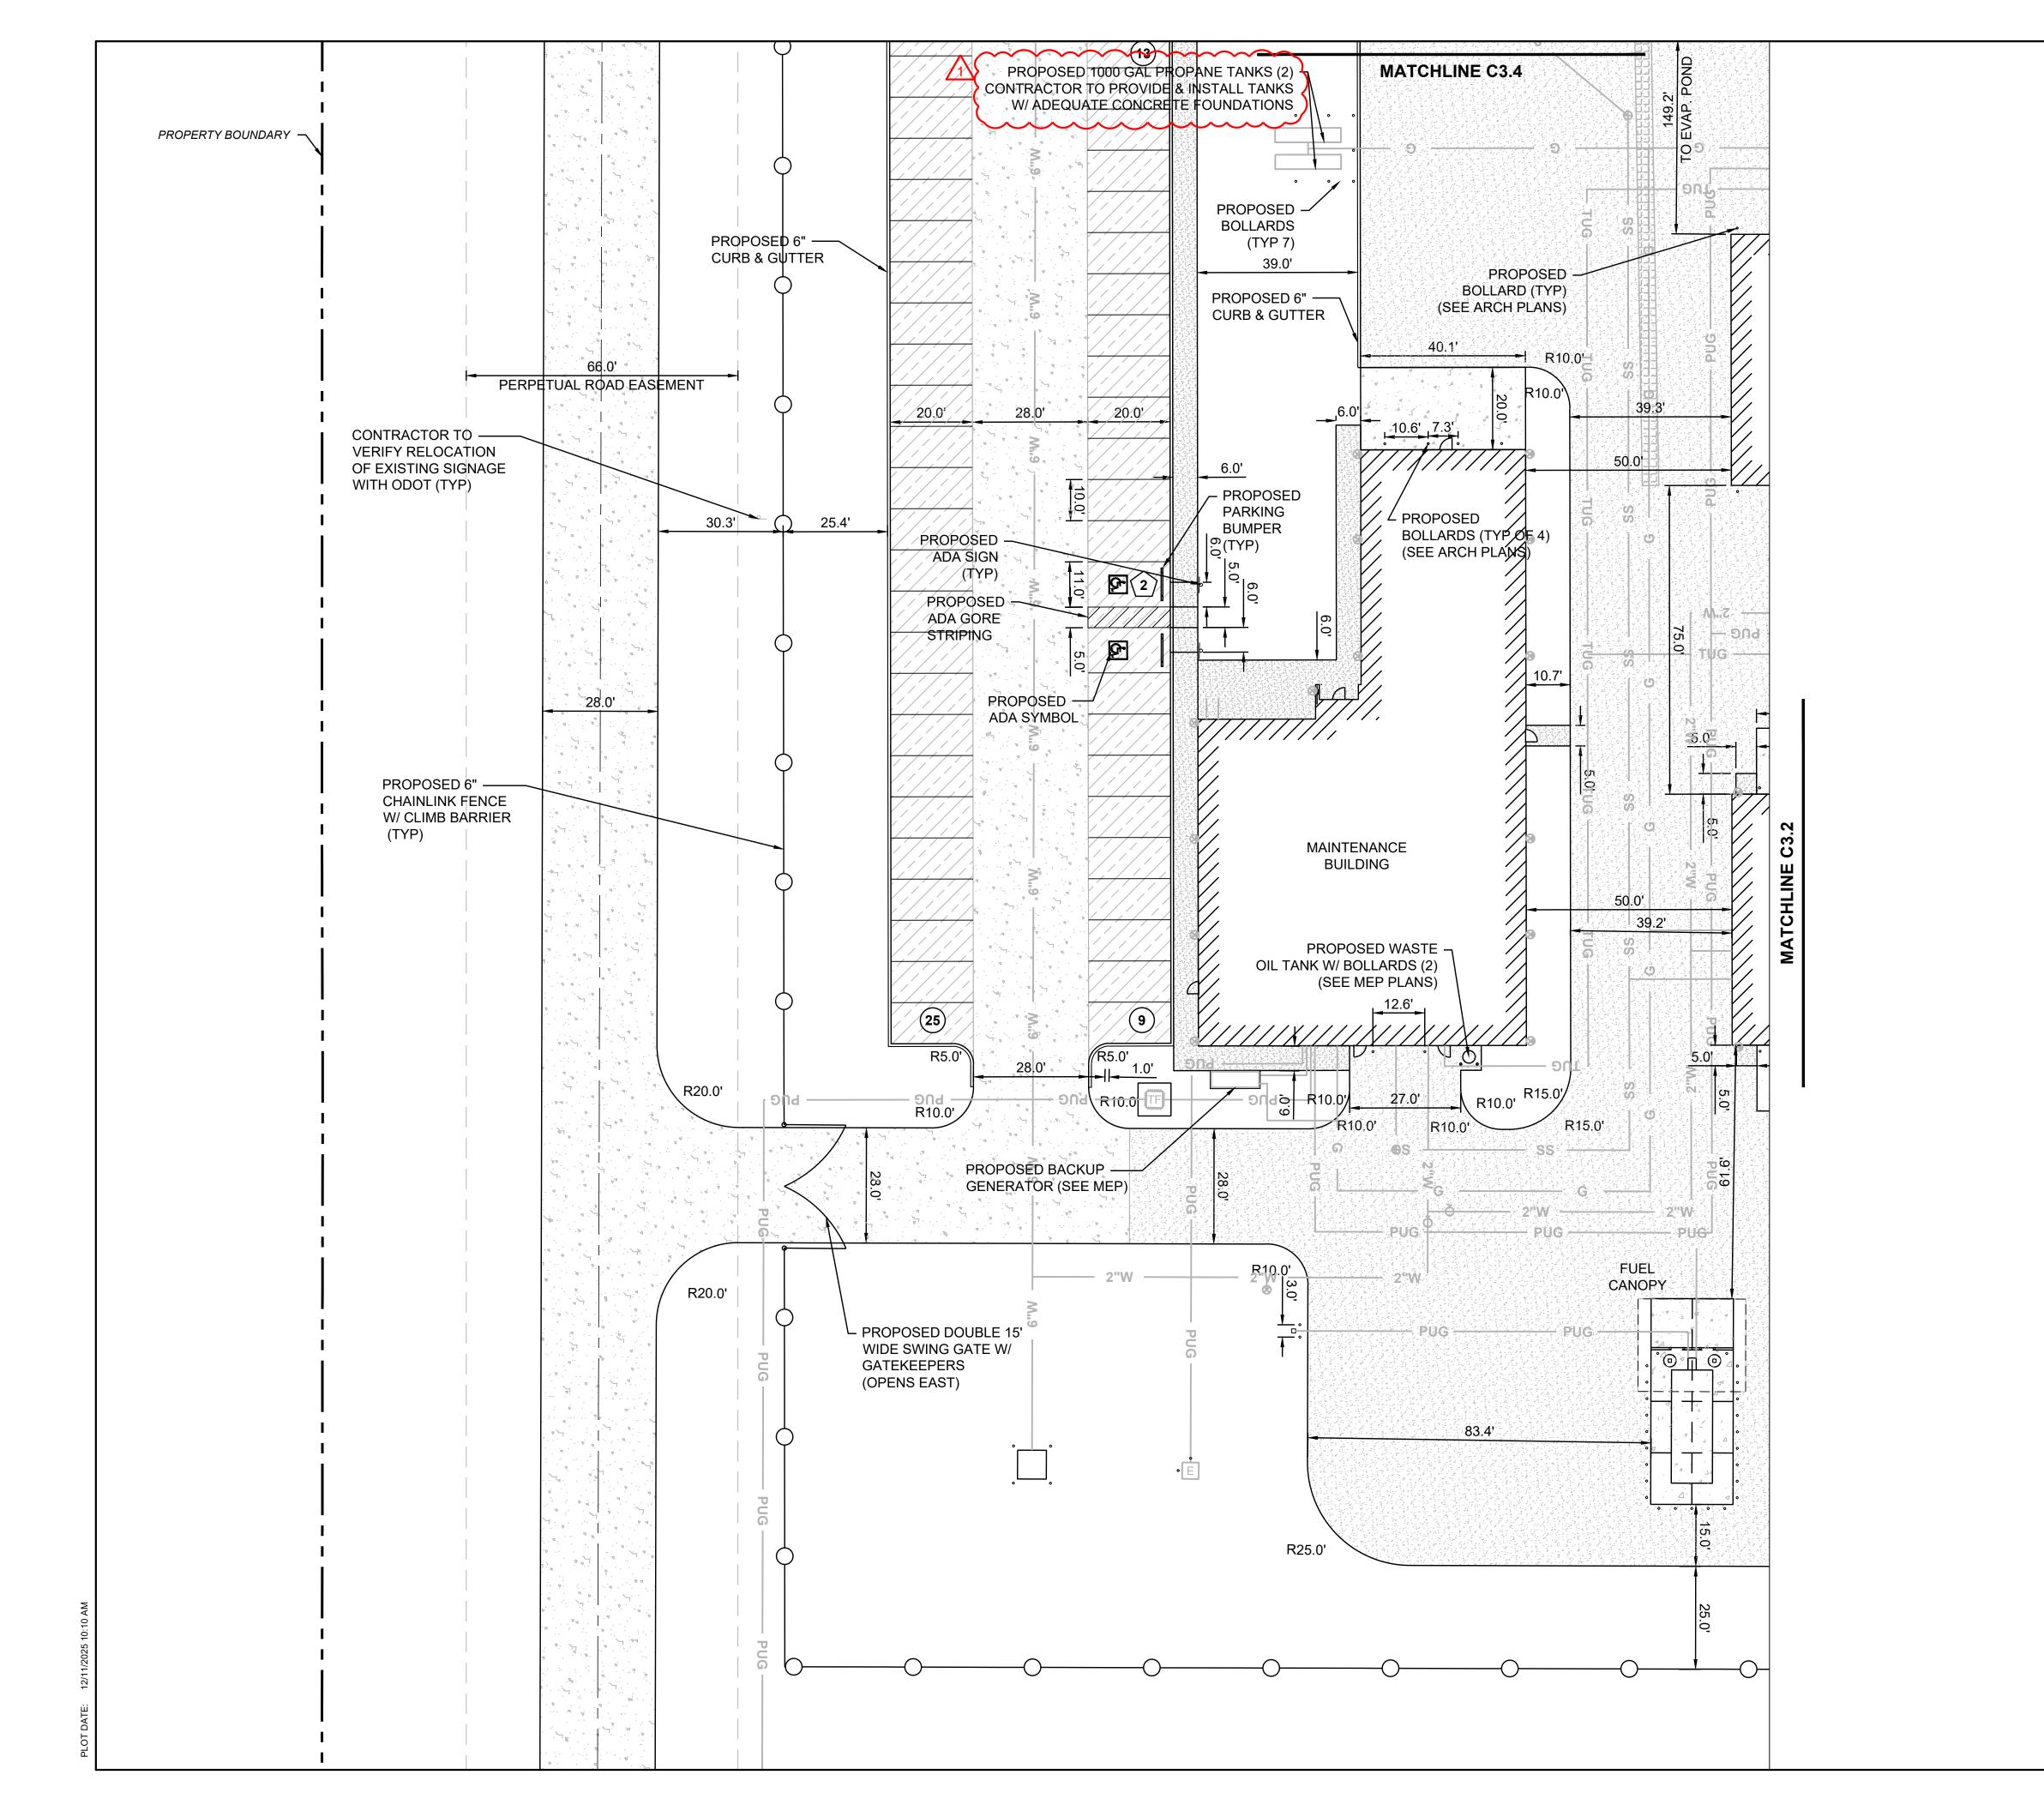

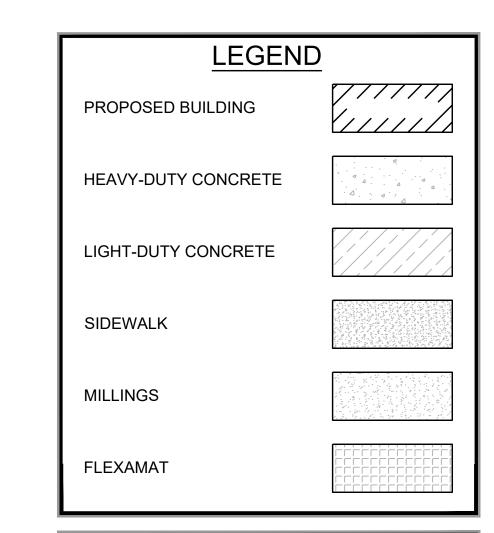

PARKIN	IG TABLE
STALL TYPE	PROPOSED
STANDARD	47
ADA	2
TOTAL	49

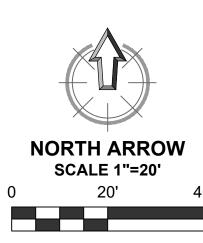

CEC CORPORATION WWW.CONNECTCEC.COM
OK CA#: 32 EXP.: 2026-06-36




MAINTENANCE FACILITY	SUBMITTAL:	SUBMITTAL: GONSTRUCTION DOCUMENTS		REVISIC
	DATE:	<del>08/</del> 08/2025	.ON	NO.   DESCRIPTION
DISTRICT 2 - BRYAN COUNTY	PROJECT NO: 240622	240622	1	ADDENDUM NO. 1
	DESIGNED BY: AMK	AMK		
OKLAHOMA DEPARTMENT OF TRANSPORTATION	DRAWN BY: AMK	AMK		
AMOUA INO FINAGLIA	APPROVED BY: KSJ	KSJ		
DONAINI, ONLAHIOMIA				


SHEET NAME

SITE PLAN

SHEET

C3.1

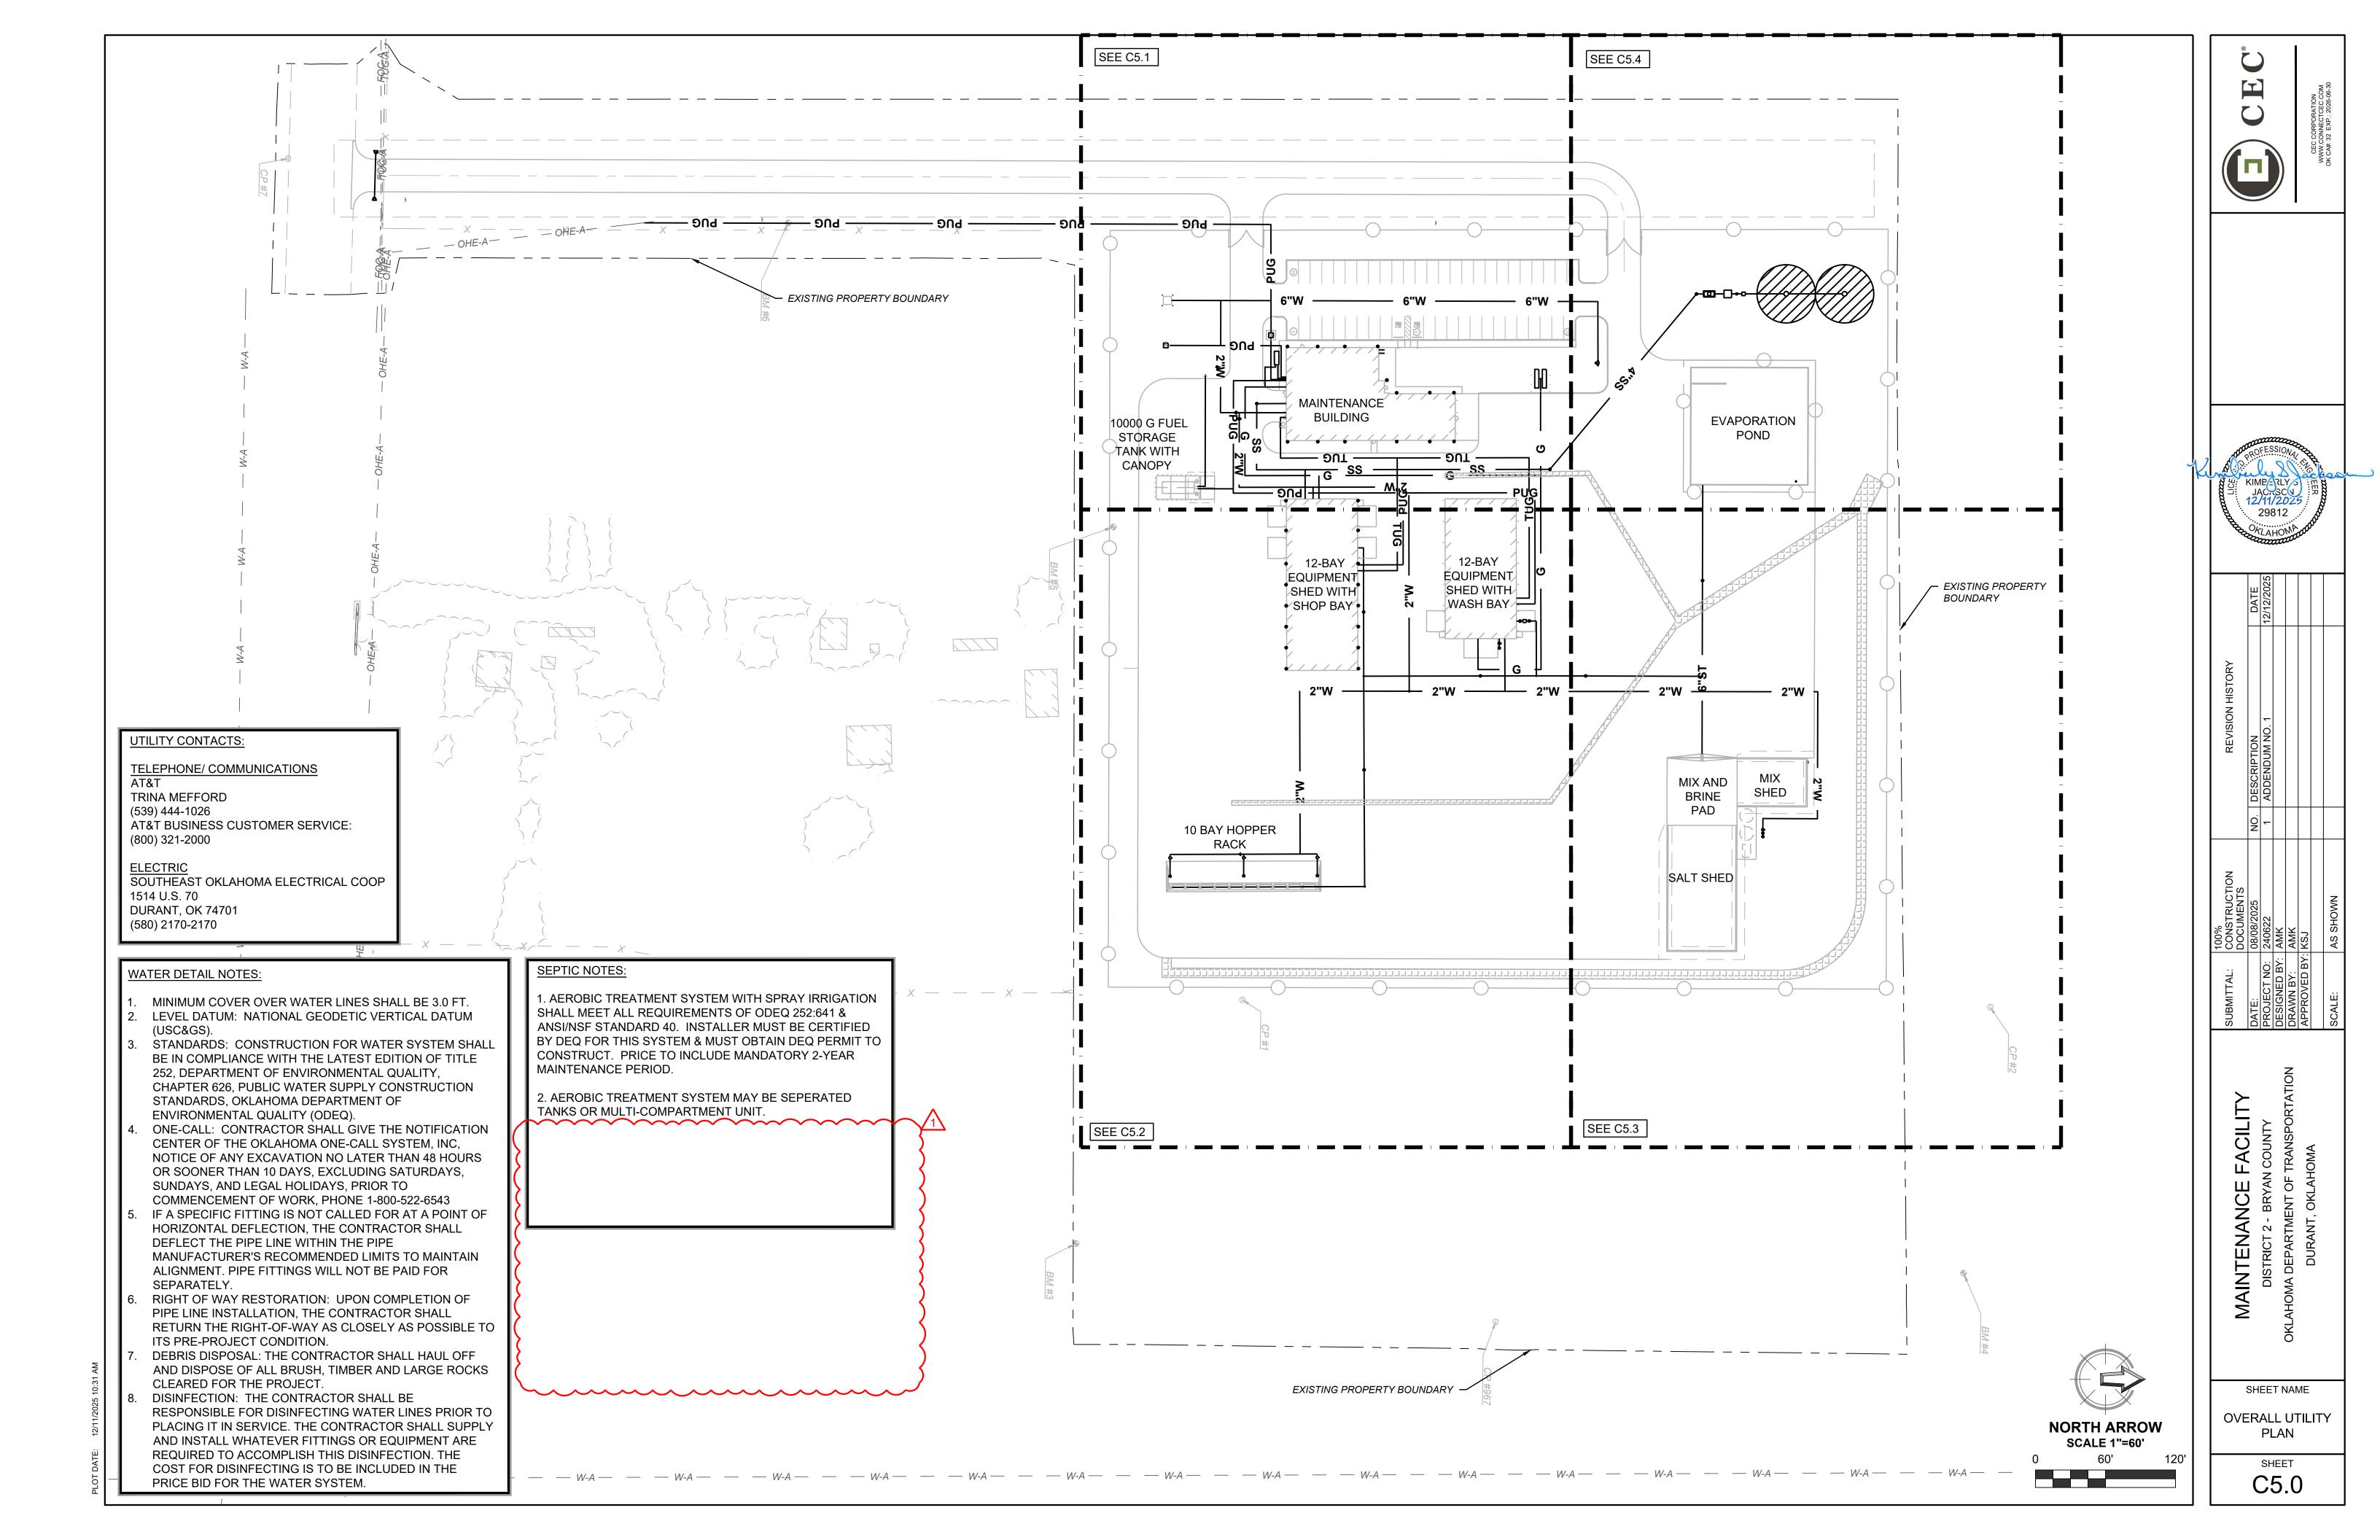

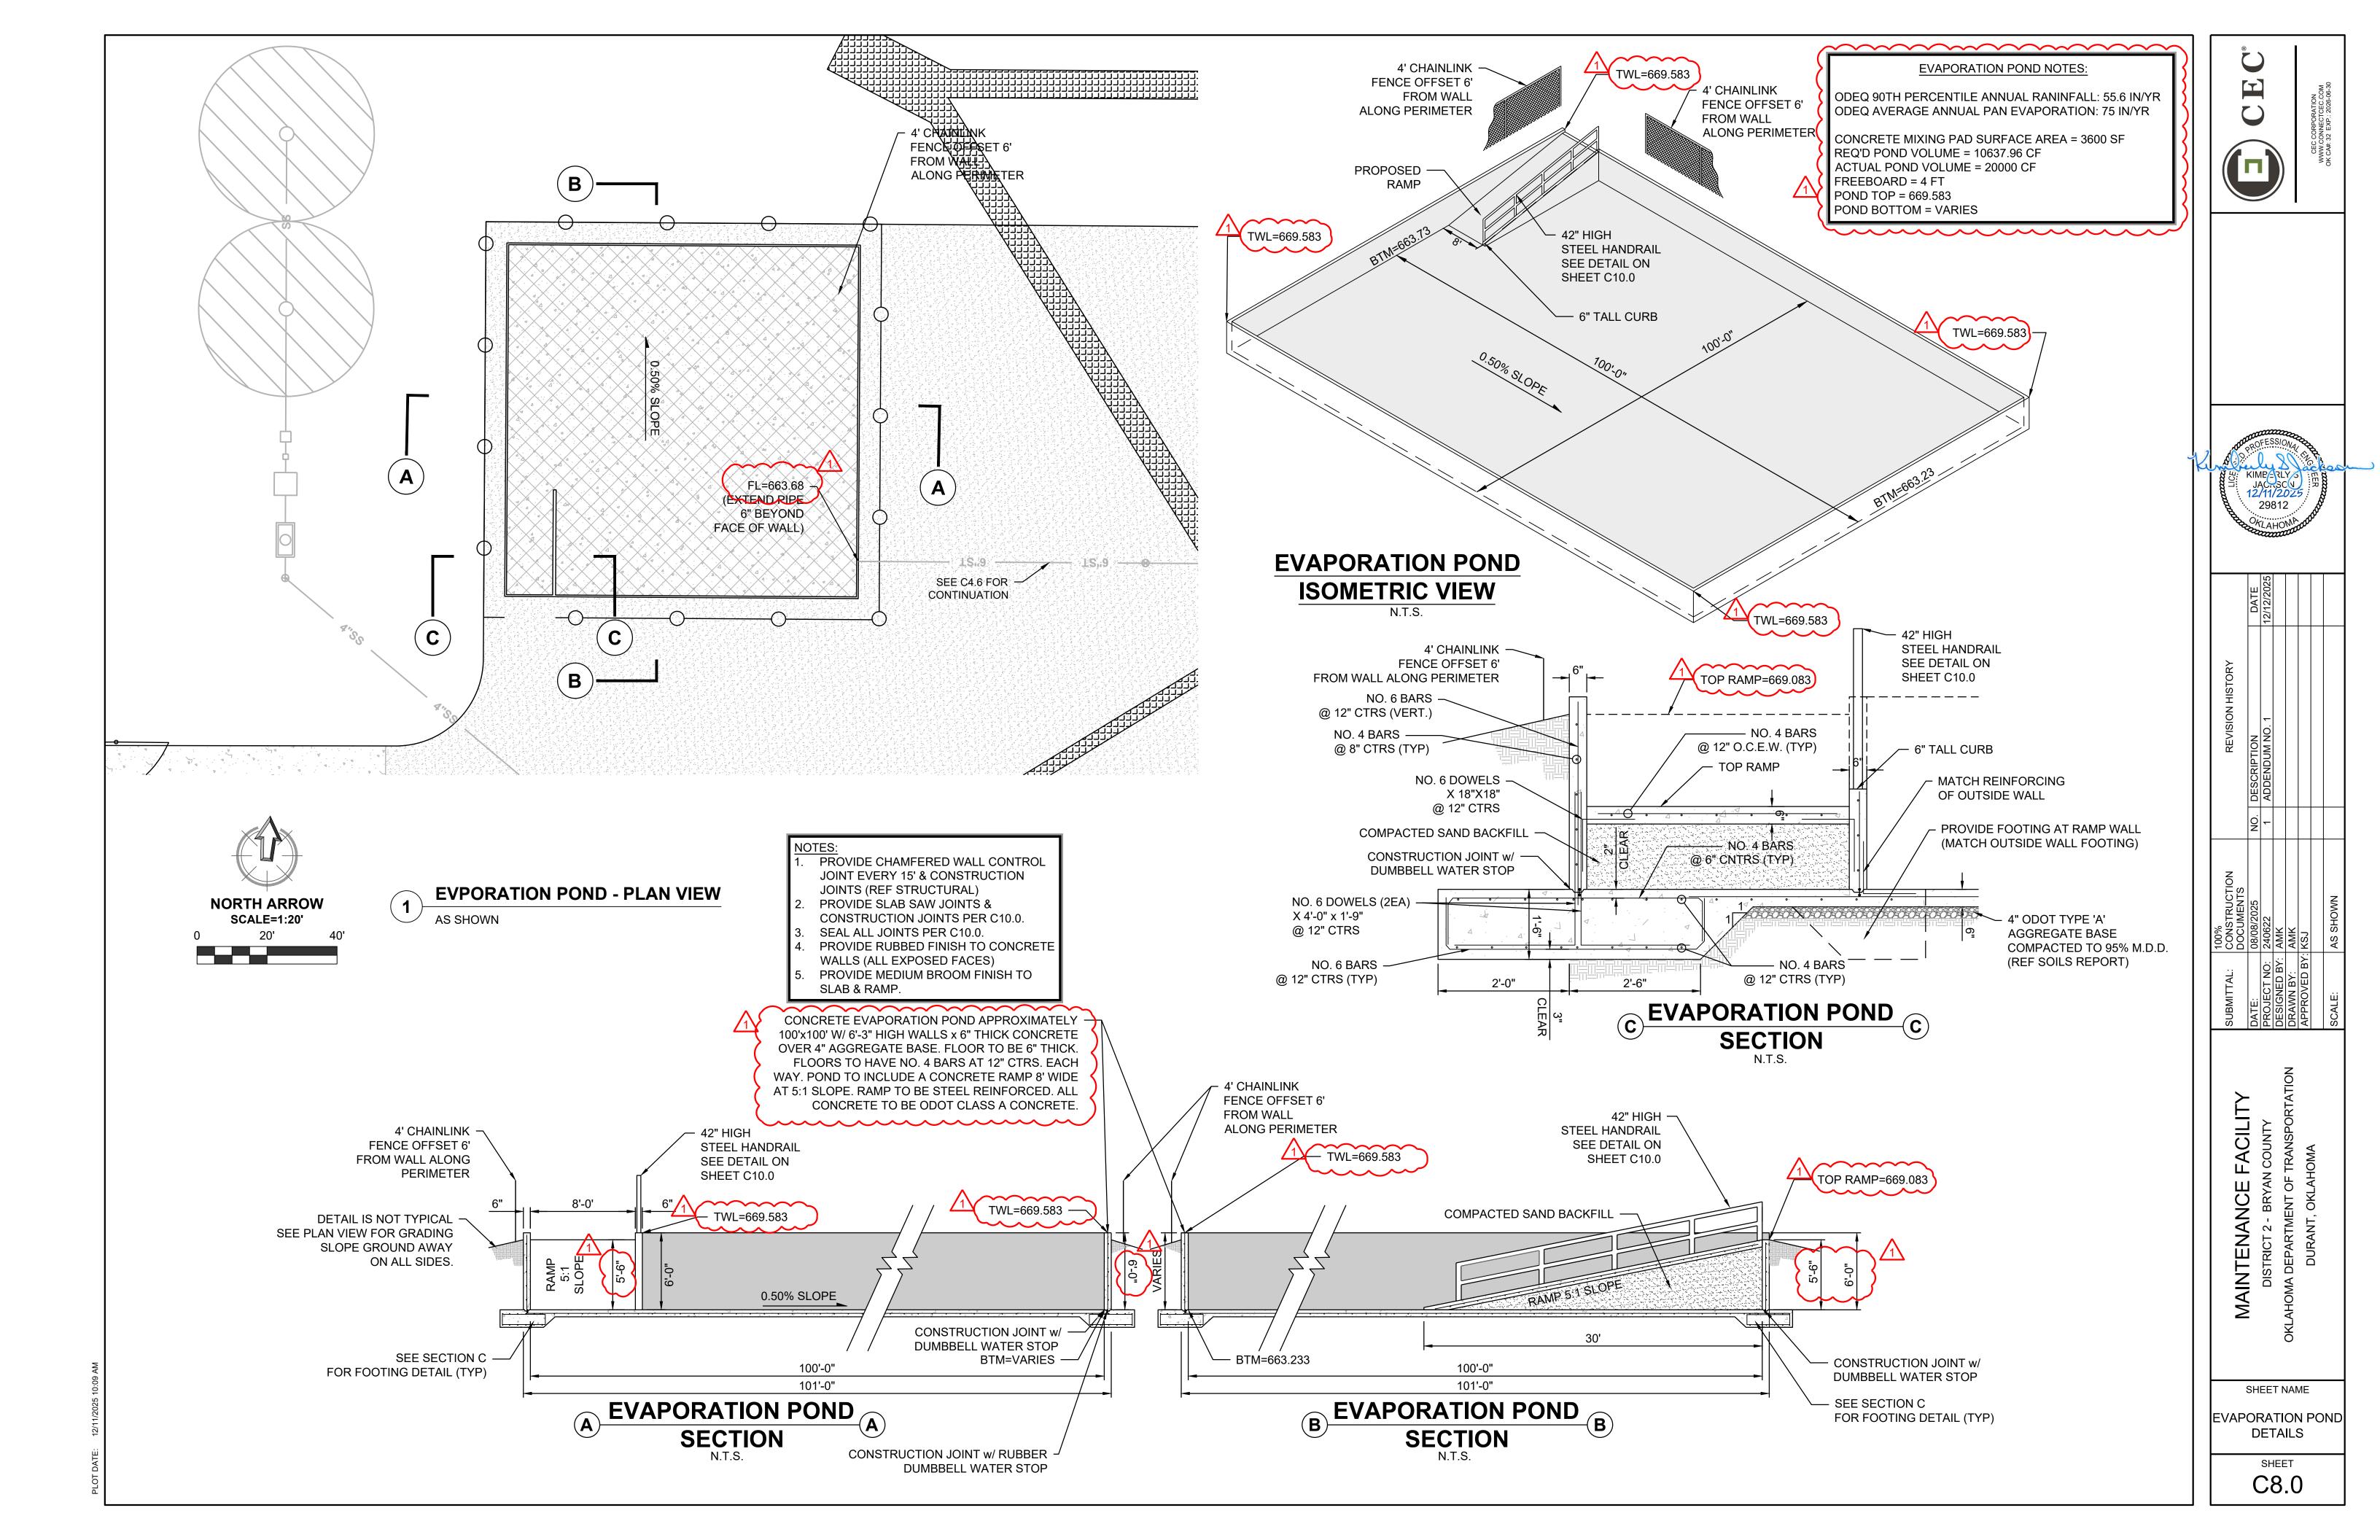

## ENVIRONMENTAL COMPLAINTS AND LOCAL SERVICES DIVISION



### REPORT FOR ON-SITE SEWAGE TREATMENT SOIL PERCOLATION OR SOIL PROFILE TEST (PLEASE PRINT or TYPE)

Work Order No.	
System No.	
Date Rec'd	

GENERAI	LINFOR	MATION:									
Name and I	Mailing A	ddress of Pr	opertyO	wner:							
Owner Pho	ne Numb	er.		Fi	rst Name	last Name		ailing Address		City	Zip Code
Owner Tho	ne rvamo	———			Owner's	E-Mail Address	(Optional):				
Property A	ddress:			Street Addre	255		City	Zin Co	de	County	, Oklahoma
Legal Desc	ription:			Sirectitativ	233		City	Lot Size in		-	acres:
_	-							_		_	
Finding Lo	cation:						(Blocks or miles from a	ı given point)			
Water Supp	oly:	☐ Indi	vidual Pı	rivate Well	or [	☐ Public Water	Supply – Name: _				
GPS Coord	inates:	Lat:									
WATERR	ODV PR	OTECTION					<u> </u>				
Dispersal fi	eld locate	d in Water E	Body Pro	tection Area	(check one	e):	Zone 2 No	one			
treatment sy treatment sy	ystem for ystem so t	a residence of that the syste	or busine m can be	ss to certify properly siz	the numberzed."	of bedrooms in	of the person contract the residence or the duplex with the follo	water usage of the boowing # of bedrooms	usiness that	will be serve	stalling an on-site sewage d by the sewage
☐ The est	imated flo	ow or actual	flow for	this small pu	ıblic sewag	e system is	$\rho$	gal/day and is	s a	Typ	e of Facility
							While			71	,,
	nt First Nam			Last Na	ıme			Signature			Date Signed
SOIL TES	T RESUI	LTS:									
			Profile D	escription	ı			Soil Percola	ation Test l	Description	
	НО	LE #1	HC	D4/* 4-	Н	OLE #3	Shallowest Grou	•			colation Rate
Depth of	Group	Depth* to Limiting	Group	Depth* to Limiting	Group	Depth* to Limiting		inches		mir	nutes/inches
Test Hole		Layer		Layer†	_	Layer <sup>†</sup>	Person completing	*	id- OAG 252		
0-6" 6-12"							*1 certify the presoak was	s conducted in compliance	colation Ra		
12-18"							Test Hole #	Test Hole D		1	ole Percolation Rate
18-24"							#1	inch	•		min/in
24-30"							#2	incl	nes		min/in
30-36"							#3	inch	nes		min/in
36-42"							#4	incl	nes		min/in
42-48"							#5	inch	nes		min/in
48"-54"	***	.1 1	<i>.</i>	T T	CHY	C IW.	#6	inch		DC D I	min/in
		pth in inches			yer: GW =	Ground Water	RX = Redox (must	be 2 consecutive in	itervals)	RC = Rock	G5 = Group 5 Soil
		TESTER US ucted the ab			profile de	escription or pe	ercolation test in co	ompliance with OA	AC 252:64	11 on	Date Test Performed
oil Tester's Sign	nature					<del>_</del>	Please Print First Name	Last Name			Certification*. Number
		Address	5			City	State	Zip	Pi	hone #	Date Signed
				Certification	Number pro		our Registration Numbe	*			
EQ USE (	NLY:										
	e <b>st Perf</b> o oil Profi	ormed by D le Test		(date): Toint Soil P	rofile	-	_	ewed and Accept ewed and Rejecto			
		Enviror	nmental Sp	ecialist's Signati	ure		Employee ID	<del></del>		Date Signed	


Revised 10/2024 DEQ Form 641-581


Work Order No.	
System No.	
Owner's Last Name	


SYSTEM D	DESIGN: Check all that apply.
TREATM  Septic '	ENT: Tank with gal. liquid capacity
DISPERSA	AL:
☐ CSA:	soil group <b>or</b> percolation rate of (min/inch) with feet of perforated pipe with storage media <b>or</b> feet of manufactured media systems. The trench bottom shall be no deeper than inches.
☐ SE:	soil group with feet of subsurface absorption trenches. The trench bottom shall be no deeper than inches.
☐ ET/A:	soil group with feet of evapotranspiration trenches. The trench bottom shall be no deeper than inches.
☐ L:	with bottom dimensions of feet by feet or a diameter of feet.
☐ DI:	soil group with agallon capacity pump tanks and feet of drip line no deeper than inches.
☐ SI:	soil group with agallon capacity pump tank and square feet of surface application area.
	An Alternative system as described on the attached DEQ Form 641-581 Sup, "Supplemental Application for an Alternative System".
LOCATION	OF TEST HOLES: Show the location of all test holes in relation to two fixed reference points in the sketch box below.
	SKETCH BOX  N  W



**REMARKS:** 

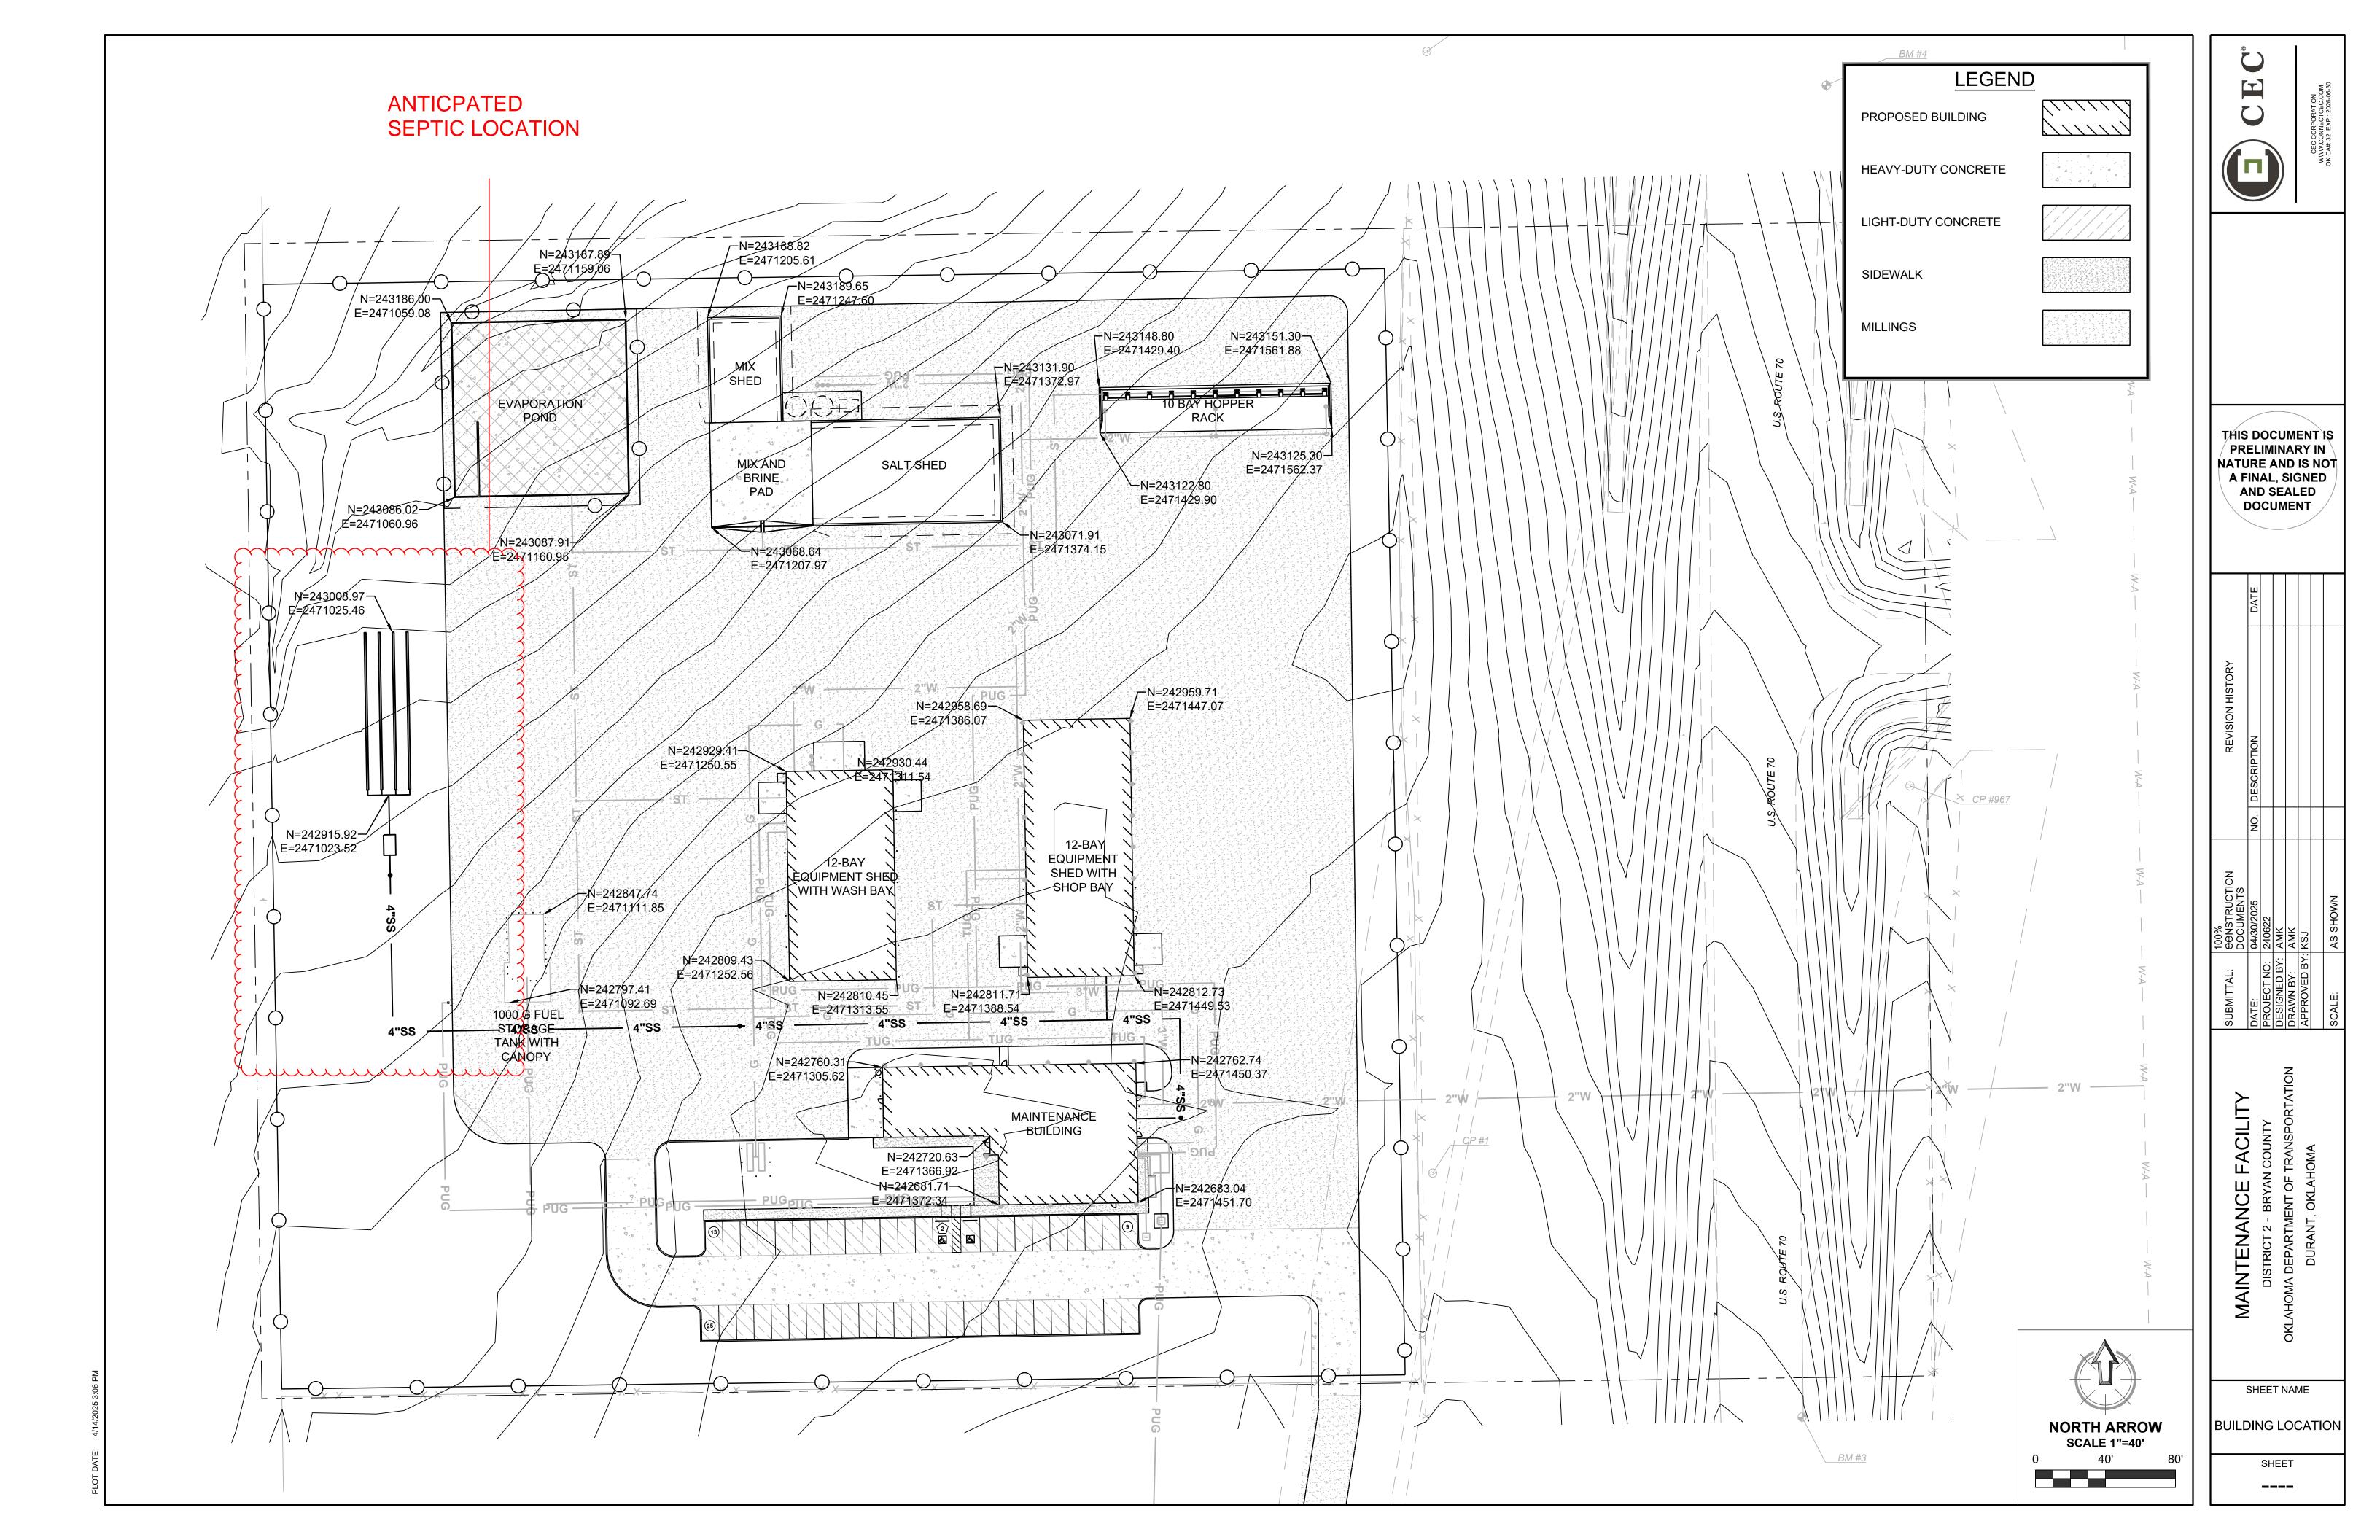

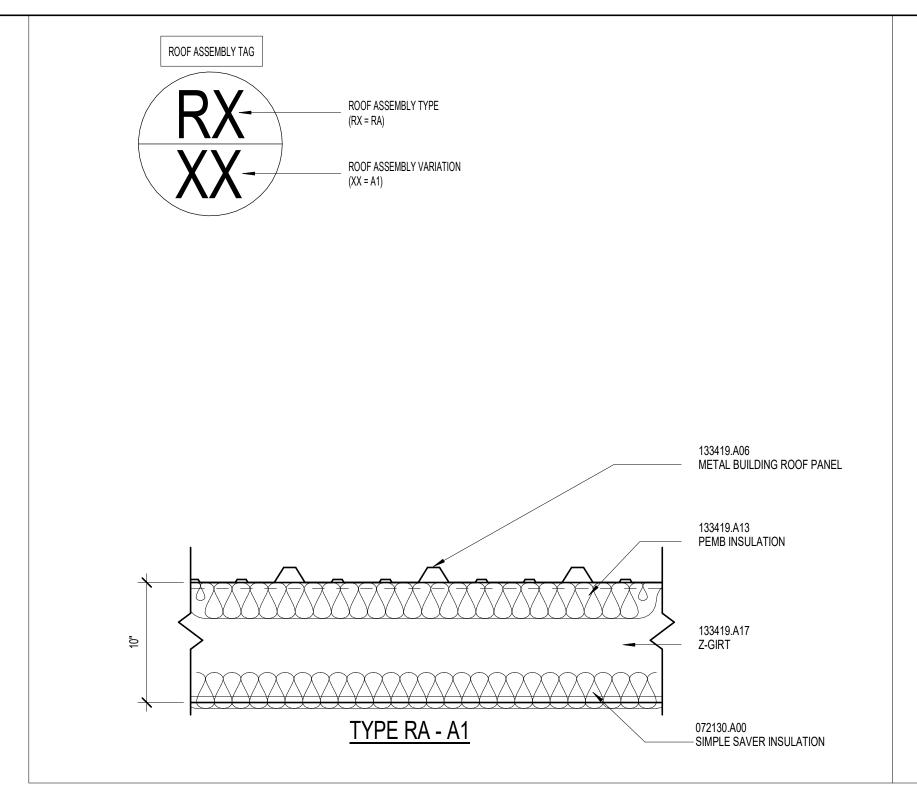


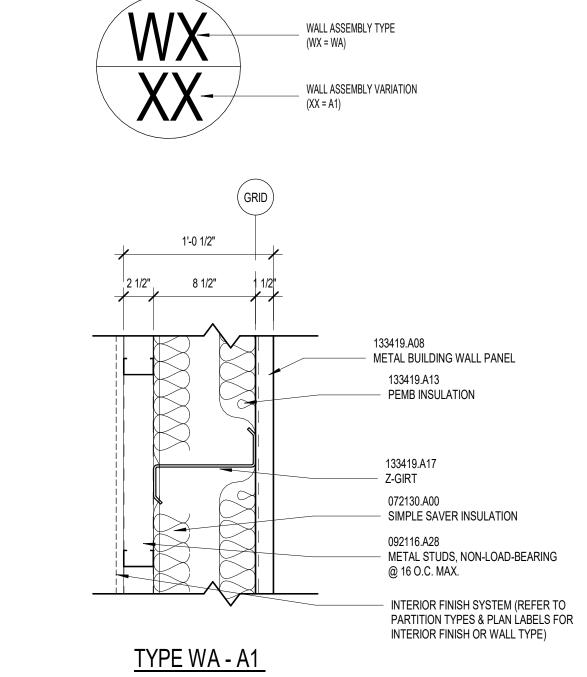


WALL ASSEMBLY TAG

# INTERIOR PARTITION LEGEND

- ALL PARTITIONS SHALL BE TYPE 1A3 AND EXTEND TO STRUCTURE WITH SOUND-ATTENUATION BLANKET, UNLESS NOTED OTHERWISE (U.N.O.).
- SEE FLOOR PLAN FOR PARTITIONS MARKED WITH A NUMERIC LINE SYMBOL DENOTING FIRE-RATED PARTITIONS AND OBSERVE THE UL FIRE-RATING CONSTRUCTION INSTRUCTIONS.
- STUDS AND FURRING STRIPS SHALL BE SPACED A MAXIMUM OF 16" O.C. WHERE TILE IS INDICATED IN THE ROOM FINISH SCHEDULE AND ELEVATIONS, PROVIDE TILE BACKER BOARD.
- STUD SIZES SHALL CONFORM TO THE SIZES RECOMMENDED BY THE STUD MANUFACTURER FOR THE PARTITION HEIGHT AT EACH LOCATION.
- EXTEND GWB TO STRUCTURE ON ALL WALLS THAT DO NOT HAVE A
- PROVIDE DEFLECTION TRACK AT ALL PARTITIONS THAT EXTEND TO STRUCTURE. REFER TO DETAILS A & B ON A0.2. ALL PARTITIONS WITH SOUND-ATTENUATION BLANKETS ARE TO BE
- CONSIDERED ACOUSTICAL PARTITIONS. SEAL TOP AND BOTTOM AND SEAL ALL PENETRATIONS TO INCLUDE DUCTWORK, PIPING, AND CONDUIT. 9. FOR PARTITIONS THAT ABUT CEILING, EXTEND GWB 6" ABOVE CEILING.
- 10. WALL PARTITION TAG ONLY REFERS TO WALL ASSEMBLY & NOT TO WALL FINISHES. 11. REFER TO FINISH SCHEDULE & INTERIOR ELEVATIONS FOR EXTENTS OF FINISHES.
- 12. ALL PLAN DIMENSIONS ARE FROM FACE OF FINISH TO FACE OF FINISH/CMU
  OR FROM FACE OF FINISH TO FACE OF MASONRY, UNLESS NOTED
- 13. NO EXPOSED STUDS WILL BE PERMITTED IN ACCESSIBLE AREA.
- ALL WOOD BLOCKING IN THE BUILDING SHALL BE FIRE TREATED LUMBER. 15. ALL GYPSUM BOARD SHALL BE TAPED, BEDDED, AND SANDED, HAVING NO HOLES AND HAVING ALL VOIDS SEALED, UNLESS NOTED OTHERWISE ON THE DRAWINGS.
- 16. ALL PENETRATIONS OF PIPES, CONDUITS, DUCTS, VENTS, ETC, SHALL BE TIGHTLY SEALTED TO PREVENT PASSAGE OF SMOKE AND FIRE COMMENSURATE WITH RATING OF THE PARTITION.

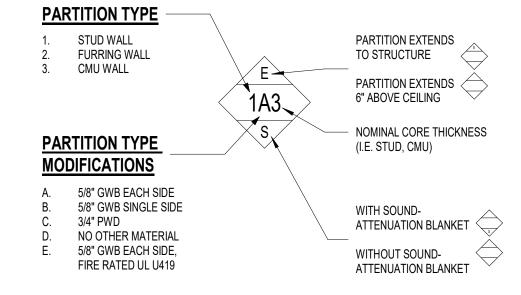


WALL TYPE	SIZE	<u>DESIGNATION</u>
STUD	2 1/2" 3 5/8" 6" 8"	2 3 6 8
FURRING WALL	7/8" 1 1/2" 2 1/2"	1 2 3
CMU	7 5/8"	8

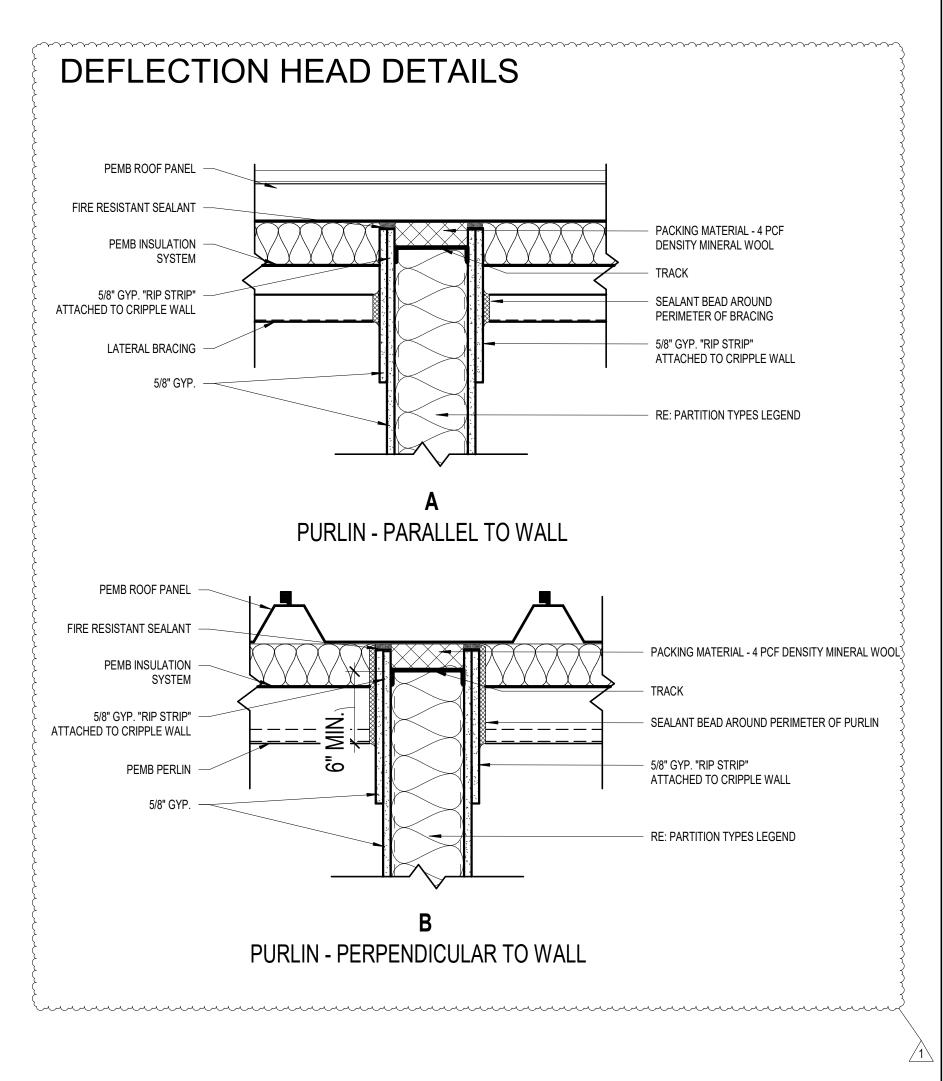








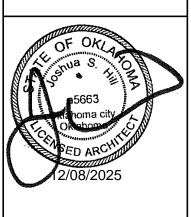


FAL:	CONSTRUCTION DOCUMENTS		REVISION HISTORY	
	08/08/2025	NO.	NO. DESCRIPTION	DATE
T NO:	T NO: 240622	1	ADDENDUM NO. 1	12/05/2025
ED BY:				
BY:	DCL			
ED BY: SH	HSC			
	AS INDICATED			


SHEET NAME ABBREVIATIONS, LEGENDS, ASSEMBLIES, **GENERAL NOTES** SHEET

A0.2

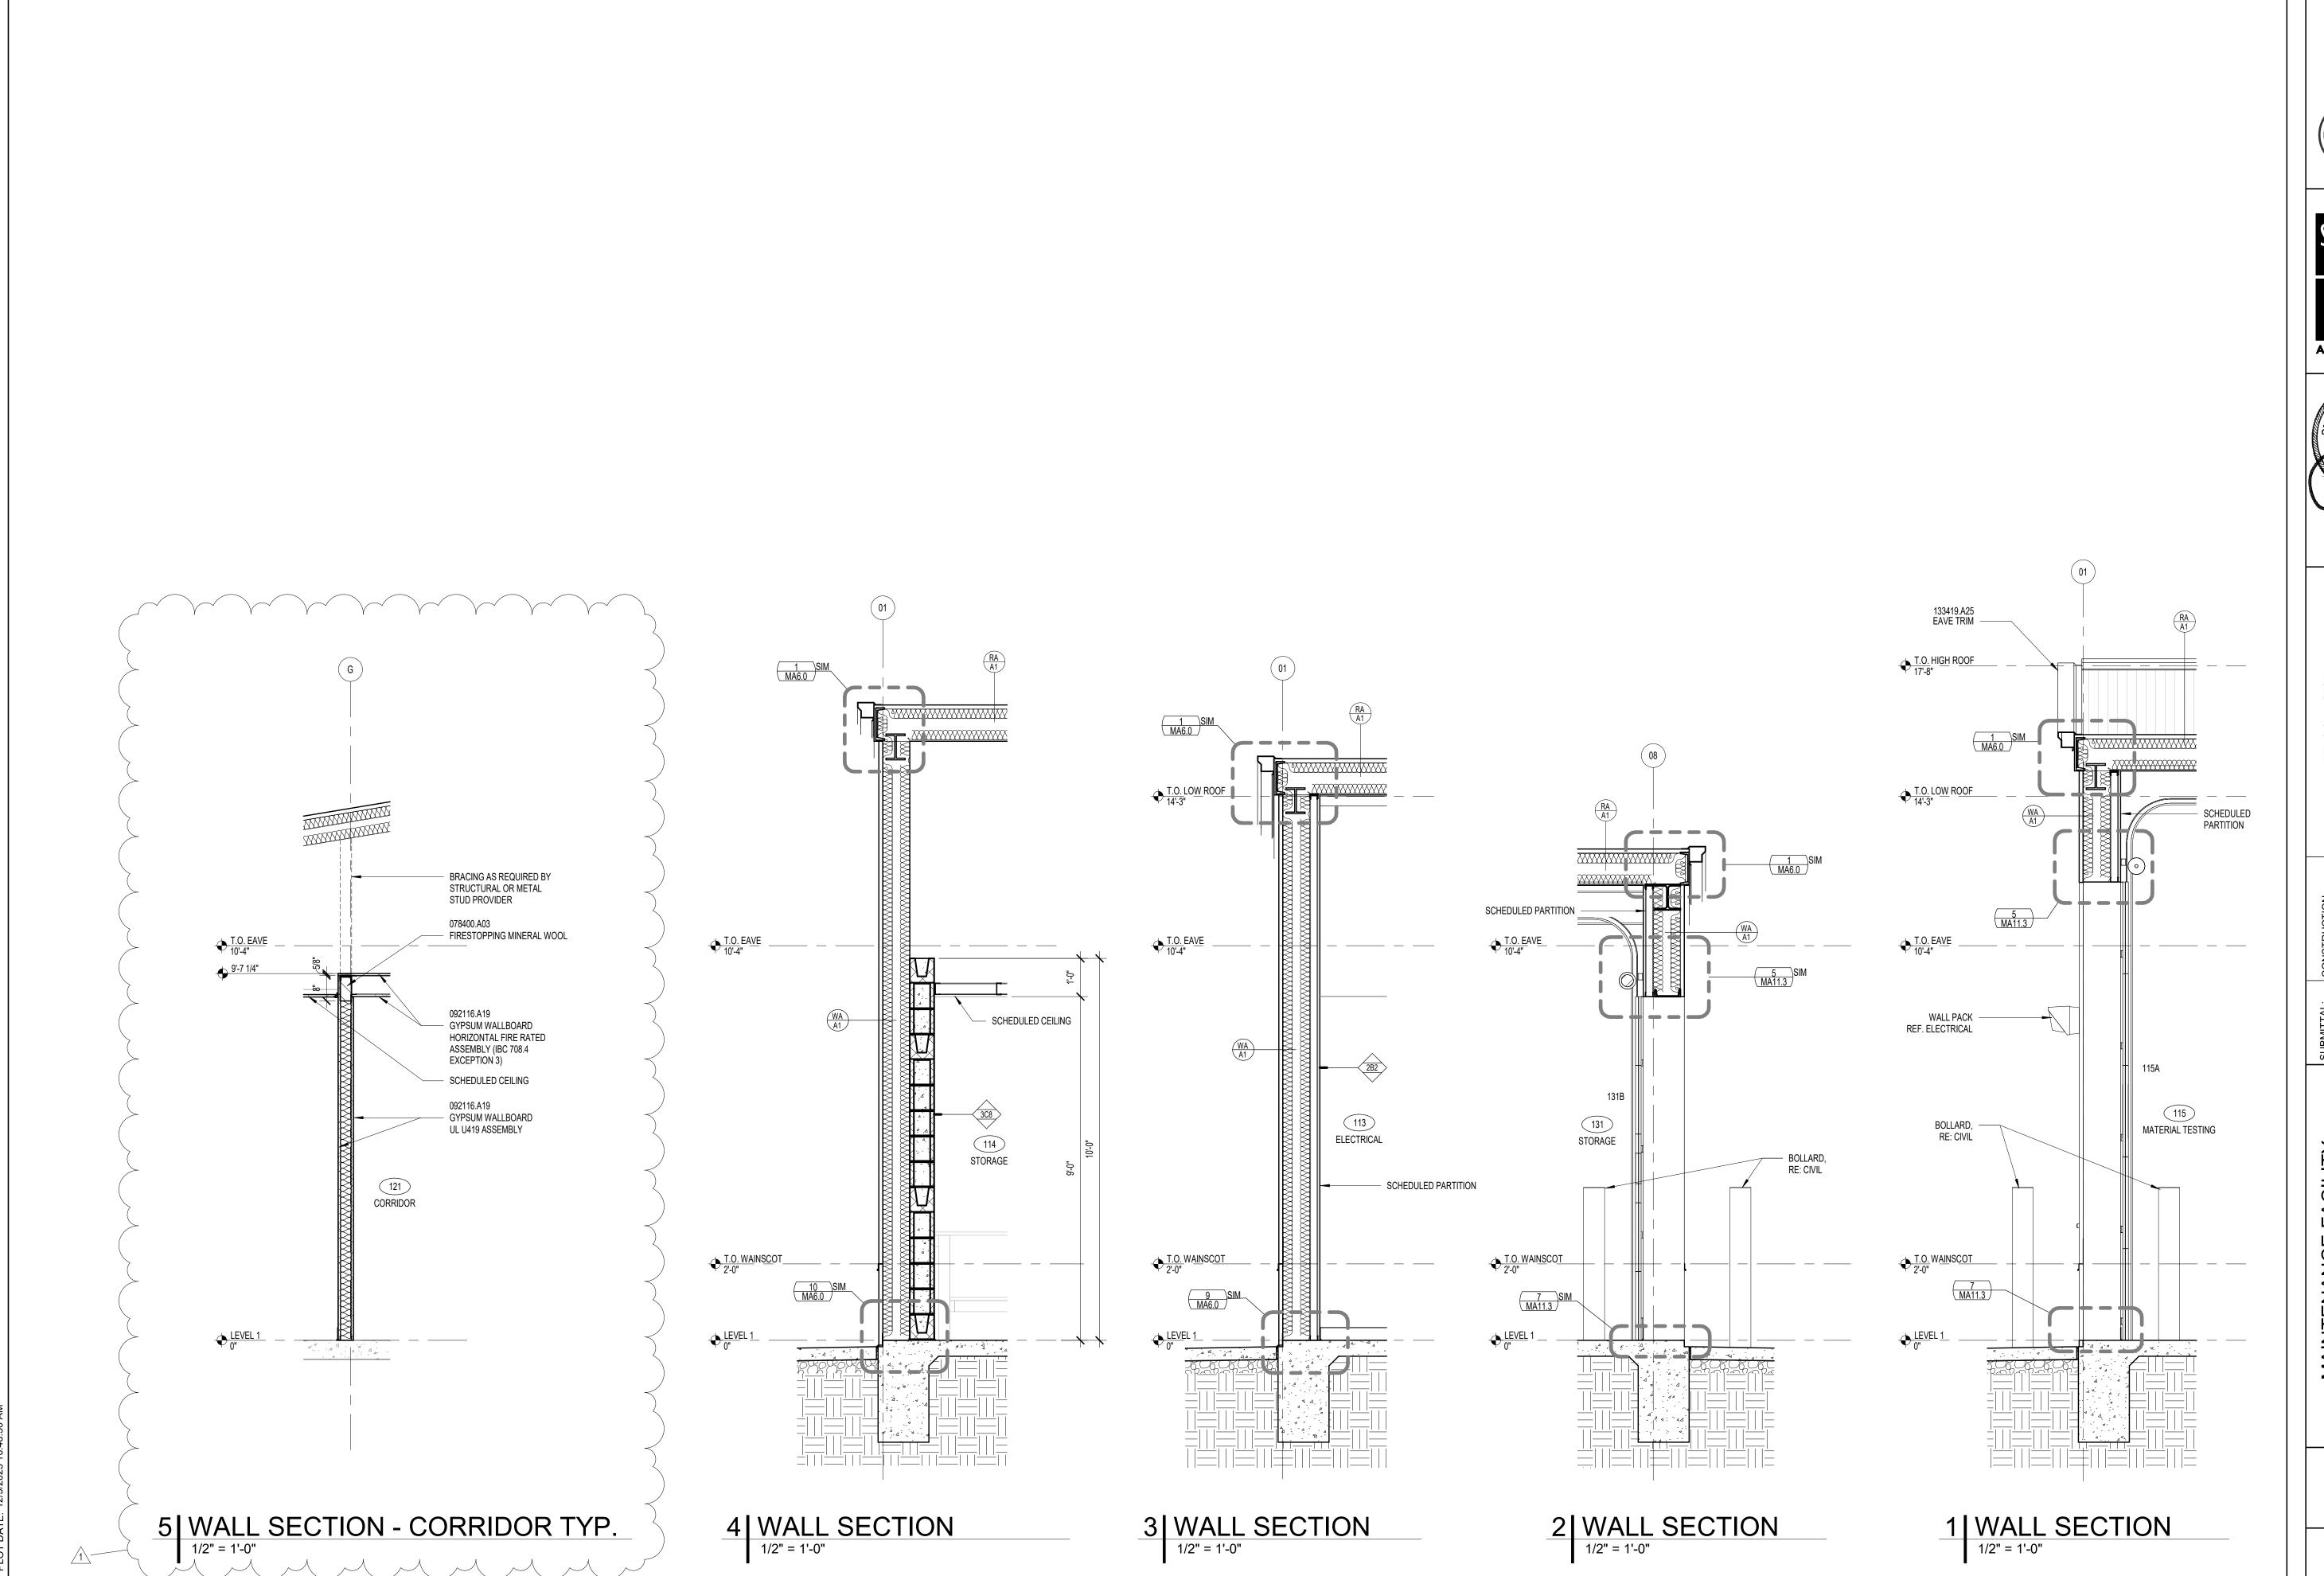



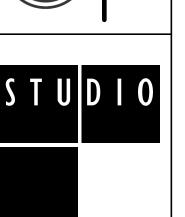

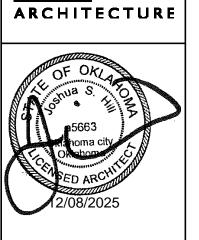

CONSTRUCTION DOCUMENTS		REVISION HISTORY	
08/08/2025	NO.	NO. DESCRIPTION	DATE
240622	1	ADDENDUM NO. 1	12/05/2025
DCL			
HSC			
AS INDICATED			

<b>.</b>		DOCUMENTS
	DATE:	08/08/2025
į	PROJECT NO: 240622	240622
<b>≻</b>	DESIGNED BY:	
	DRAWN BY:	DCL
SPORIATION	APPROVED BY: JSH	HSf
	SCALE:	AS INDICATED

MAIN LENANCE FACILII Y & RESIDENCY	DISTRICT 2 - BRYAN COUNTY	(LAHOMA DEPARTMENT OF TRANSPORTATION	DURANT, OKLAHOMA
---------------------------------------	---------------------------	--------------------------------------	------------------

SHEET NAME

WALL SECTIONS

MA5.2

		DOC	)R		FRAME			DETAIL			<u> </u>
NUMBER	WIDTH	HEIGHT	THICKNESS	MATERIAL	MATERIAL	HARDWARE	SILL	JAMB	HEAD	NOTES	
											_
E101A	3'-0"	7'-0"	1 3/4"	HM	НМ	3.0	13/EA3.0	3 & 12/EA3.0	3/EA3.0 SIM	INSULATED, PROVIDE WEATHERSTRIPPING AROUND DOOR	-
E101B	3'-0"	7'-0"	1 3/4"	НМ	НМ	3.0	13/EA3.0	3 & 12/EA3.0	3/EA3.0 SIM	INSULATED, PROVIDE WEATHERSTRIPPING AROUND DOOR	-
E101C	16'-0"	12'-0"	1 3/4"	STEEL	STEEL	4.0	-	3/EA3.0	4/EA3.0		_
E101D	16'-0"	12'-0"	1 3/4"	STEEL	STEEL	4.0	-	3/EA3.0	4/EA3.0		_
E101E	16'-0"	12'-0"	1 3/4"	STEEL	STEEL	4.0	-	3/EA3.0	4/EA3.0		
E101F	16'-0"	12'-0"	1 3/4"	STEEL	STEEL	4.0	-	3/EA3.0	4/EA3.0		
E101H	3'-0"	7'-0"	1 3/4"	НМ	НМ	3.0	13/EA3.0	3 & 12/EA3.0	3/EA3.0 SIM	INSULATED, PROVIDE	

DOOR SCHEDULE

# CODE ANALYSIS MATERIAL SCHEDULE

### STRUCTURE DESCRIPTION:

PRE-ENGINEERED METAL BUILDING USED FOR OPEN-AIR EQUIPMENT STORAGE AND AN ENCLOSED SHOP BAY.

### APPLICABLE CODES:

INTERNATIONAL BUILDING CODE 2018 INTERNATIONAL FIRE CODE 2018 INTERNATIONAL FUEL GAS CODE 2018 INTERNATIONAL MECHANICAL CODE 2018 INTERNATIONAL PLUMBING CODE 2018 NATIONAL ELECTRICAL CODE 2017

AMERICAN WITH DISABILITIES ACT 2010

### **CONSTRUCTION TYPE:**

II-B ( SECTION 602.2) NOT SPRINKLERED

### OCCUPANCY TYPE:

ALLOWABLE BUILDING SIZE:

MIXED USE S-1/U (SECTION 312)

### 55 FT HEIGHT (U): STORIES (Ú):

8,500 SF AREA (U):

### ACTUAL BUILDING SIZE:

HEIGHT: 20'-4" STORIES: 8,966 SF (FIRE AREA) AREA:

# SPECIAL USE AND OCCUPANCY REQUIREMENTS:

903 - AUTOMATIC SPRINKLER SYSTEMS -903.2.9.1 GROUP S-1 REPAIR GARAGES: AN AUTOMATIC SPRINKLER SYSTEM SHALL BE PROVIDED THROUGHOUT ALL BUILDINGS USED AS REPAIR GARAGES IN ACCORDANCE WITH SECTION 406, AS SHOWN:

> .4 A GROUP S-1 FIRE AREA USED FOR THE REPAIR OF COMMERCIAL MOTOR VEHICLES WHERE THE FIRE AREA EXCEEDS 5,000SF (3,148 SF ACTUAL USED FOR COMM. MOTOR VEHICLE REPAIR: NO SPRINKLER REQUIRED)


202 - FIRE AREA: THE AGGREGATE FLOOR AREA ENCLOSED AND BOUNDED BY FIRE WALLS, FIRE BARRIERS, EXTERIOR WALLS, OR HORIZONTAL ASSEMBLIES

# FIRE RESISTANCE RATING REQUIREMENTS (SECTION 601):

PRIMARY STRUCTURAL FRAME: 0 HR EXTERIOR BEARING WALLS: 0 HR INTERIOR BEARING WALLS: 0 HR EXTERIOR NONBEARING WALLS & PARTITIONS: 0 HR INTERIOR NONBEARING WALLS & PARTITIONS: 0 HR FLOOR CONST. & SECONDARY MEMBERS: 0HR ROOF CONST. & SECONDARY MEMBERS: 0HR

### MONITORED FIRE ALARM REQUIRED AND IS PROVIDED. -



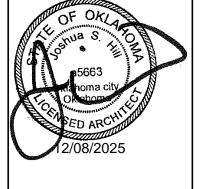

	DATE	08/27/2025			
REVISION HISTORY	NO. DESCRIPTION	ADDENDUM NO 1			
	Ö.	_			
RUCTION (ENTS	025				טעדנט

		DOCUMENIS
	DATE:	08/08/2025
	PROJECT NO:	240622
	DESIGNED BY:	-
	DRAWN BY:	JGI
NO	APPROVED BY: JSH	JSH
1		
	SCALE	AS INDICATED

MAINTENANCE

SHEET NAME FLOOR PLAN

SHEET EA1.0

STYLE / COLOR NOTES CONVERGENT CONCRETE TECHNOLOGIES PENTRA-SIL HD THROUGHOUT EQUIPMENT SHED FLOOR SLAB SIM TO: PATINA GREEN - R PANEL (1.25") 24 GA. METAL WALL PANELS OVER WAINSCOT SIM TO: CHARCOAL GRAY - R PANEL (1.25") 24 GA. METAL WALL PANELS UNDER WAINSCOT WHITE FLUROPON - R PANEL (1.25") 24 GA. METAL WALL PANELS INTERIOR WHITE FLUROPON - 12" FLAT PANEL (1") 24 GA. SOFFIT PANELS WHITE FLUROPON - R PANEL (1.25") 24 GA. ROOF PANELS SW7015 REPOSE GRAY, SATIN LOCATED ON BOLLARDS AND HOIST TEXT SW6910 DAISY ALL EXPOSED STEEL TO BE PAINTED PT6. U.N.O.

PT4 PAINT 4 SHERWIN WILLIAMS PT6 PAINT 6 SHERWIN WILLIAMS SW B42W01181 EXTRA WHITE 3/4" PLYWOOD GRADE BC, FIRE-RETARDANT TREATED, PT1 PWD1 PLYWOOD


4

NOTE: RAKE TRIM, RIDGE CAP & GUTTERS TO MATCH RP1 / MP4, DOWNSPOUTS TO MATCH MP1, WAINSCOT TRIM TO MATCH MP2. ALL BY PEMB MFR.

# **INTERIOR PARTITIONS**

- STUDS AND FURRING STRIPS SHALL BE SPACED A MAXIMUM OF 16" O.C.
- WHERE TILE IS INDICATED IN THE ROOM FINISH SCHEDULE AND/OR ELEVATIONS, PROVIDE TILE BACKER BOARD INSTEAD OF GWB.
- STUD SIZES AND SPACING SHALL CONFORM TO THE SIZES RECOMMENDED BY THE STUD MANUFACTURER FOR THE PARTITION HEIGHT AT EACH LOCATION.
- PROVIDE DEFLECTION TRACK AT ALL PARTITIONS THAT EXTEND TO STRUCTURE. REFER TO DETAILS 2 & 3 ON SHEET MA12.0.
- ALL PARTITIONS WITH SOUND-ATTENUATION BLANKETS ARE TO BE CONSIDERED ACOUSTICAL PARTITIONS. SEAL TOP AND BOTTOM AND SEAL ALL PENETRATIONS TO INCLUDE DUCTWORK, PIPING, AND CONDUIT.
- FOR PARTITIONS THAT ABUT CEILING, EXTEND WALL FINISH MATERIAL 6" ABOVE CEILING.
- WALL PARTITION TAG ONLY REFERS TO WALL ASSEMBLY & NOT TO WALL FINISHES. REFER TO FINISH SCHEDULE & INTERIOR ELEVATIONS FOR EXTENTS OF FINISHES.

WALL TYPE	SIZE	NOMINAL CORE THICKNESS
STUD / FURRING	2 1/2" 3 5/8" 6"	2 3 6
FURRING CHANNELS	1 1/2"	1

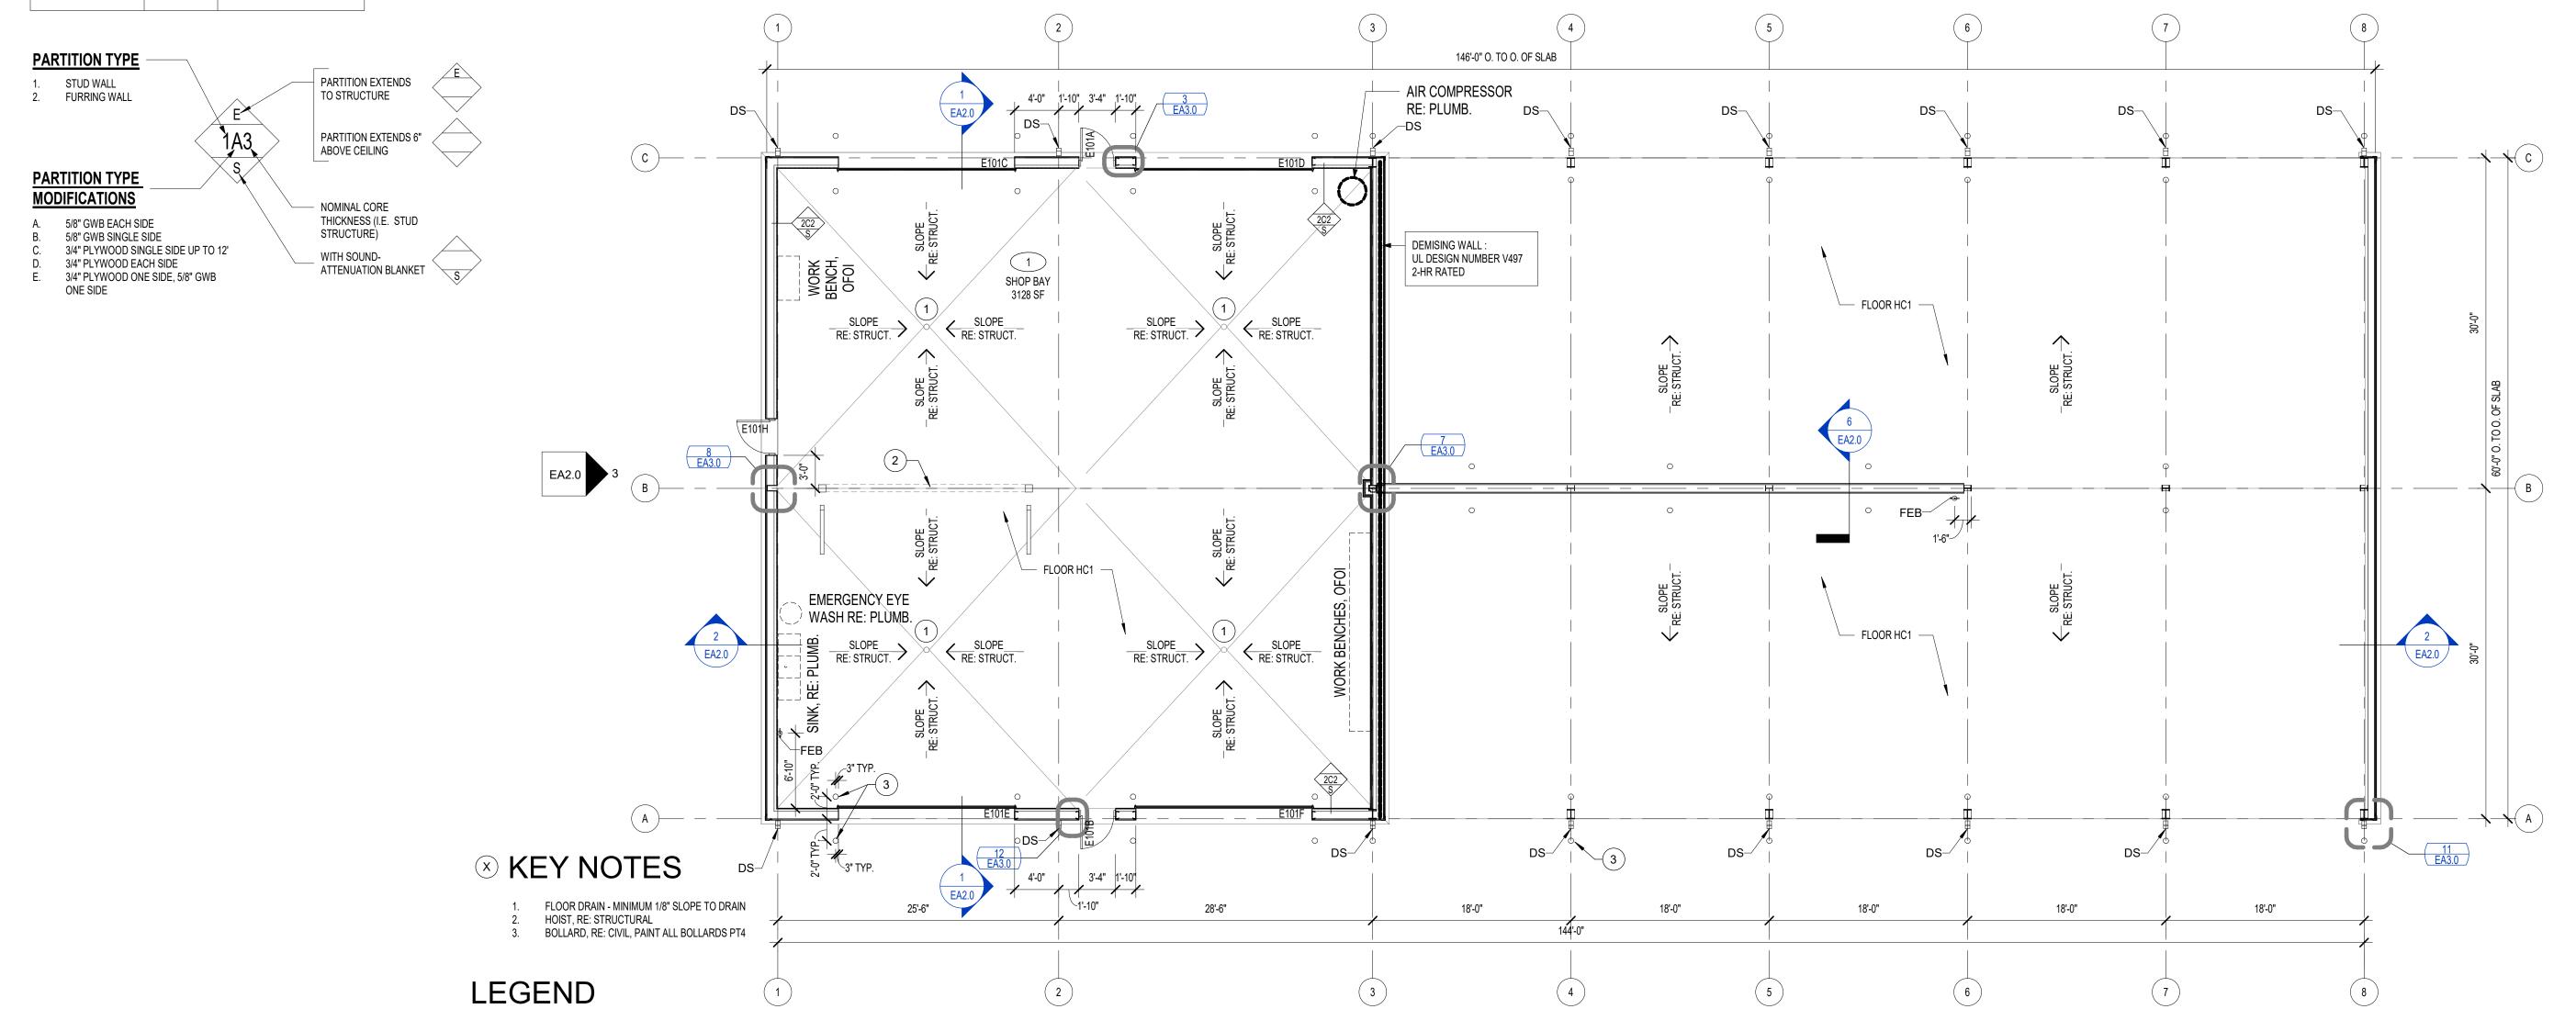

MARK MATERIAL

WEATHERSTRIPPING AROUND DOOR

HARDENED CONCRETE

PEMB MFR

PEMB MFR

PEMB MFR

PEMB MFR

SHERWIN WILLIAMS

MTL WALL PANEL

MTL WALL PANEL

MTL WALL PANEL


MTL SOFFIT PANEL

MTL ROOF PANEL

SEE CIVIL SITE PLAN FOR ORIENTATION

2 HR RATED

| FLOOR PLAN | 1/8" = 1'-0"

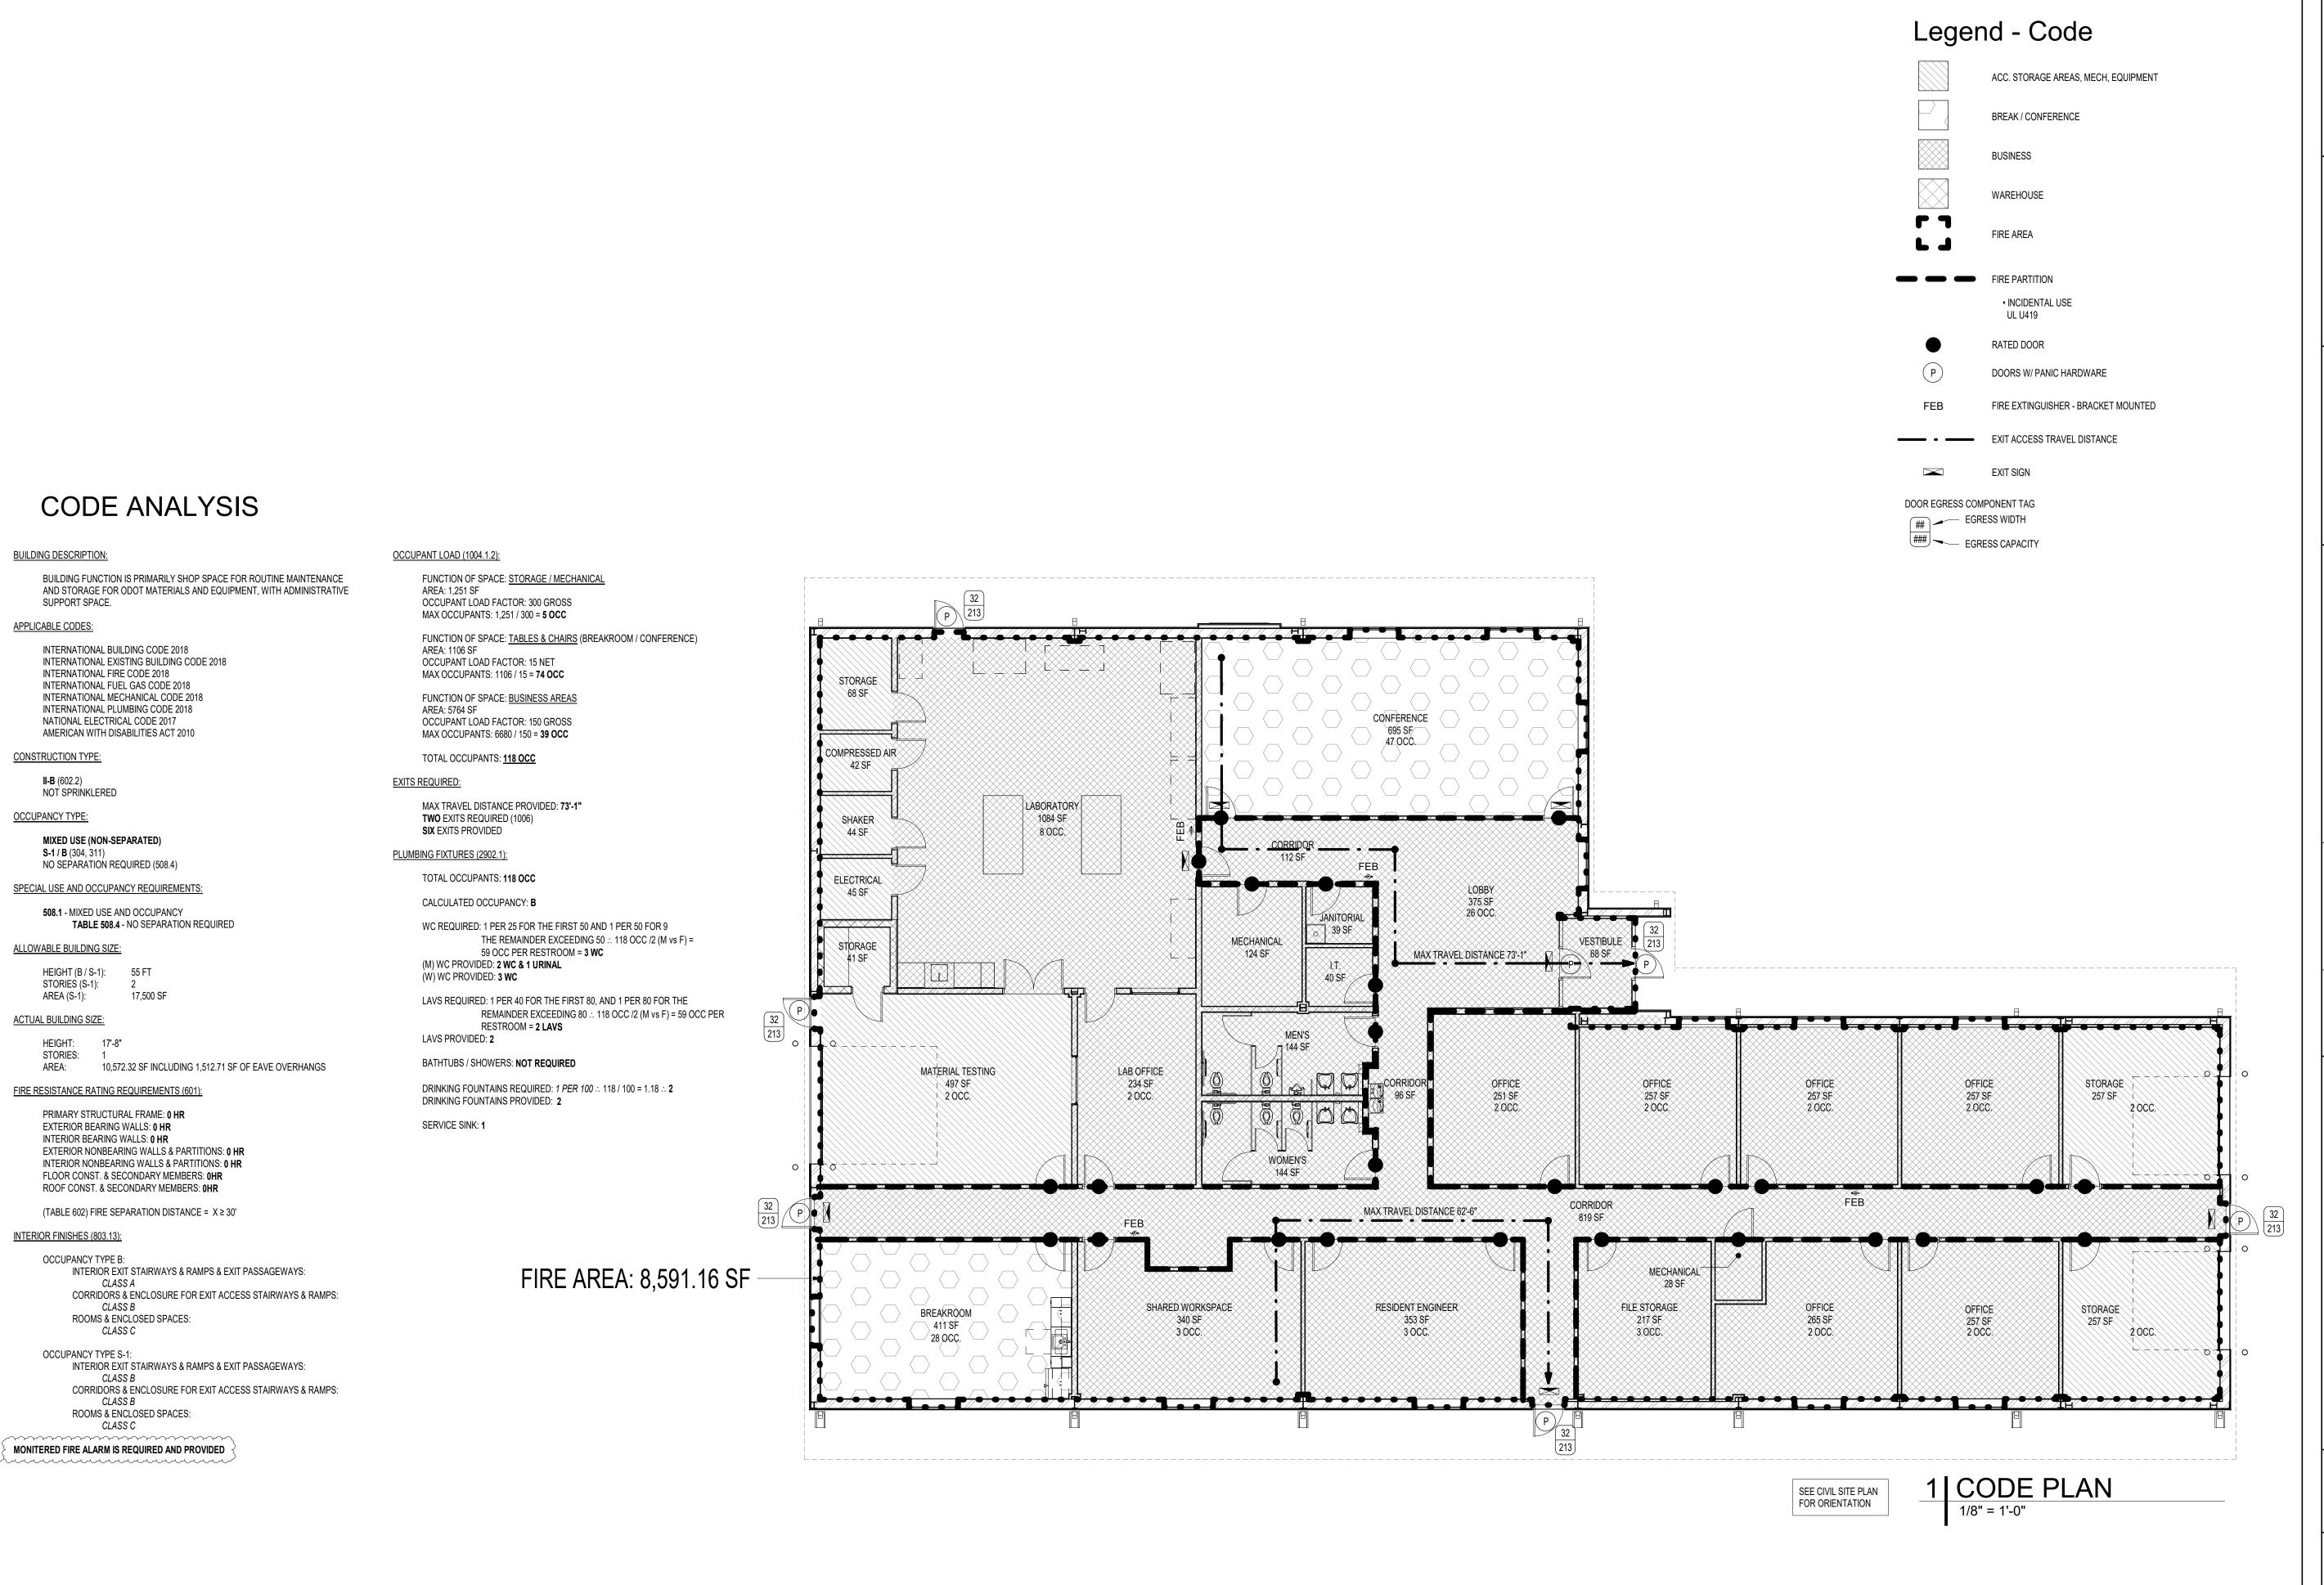







۸L:	CONSTRUCTION DOCUMENTS		REVISION HISTORY	
	08/08/2025	NO.	NO. DESCRIPTION	DATE
:NO:	NO: 240622	1	ADDENDUM NO. 1	12/05/2025
D BY:				
3Y:	DCL			
ED BY: JSH	HSf			
	AS INDICATED			

SHEET NAME

CODE ANALYSIS &

PLAN

SHEET MA1.0

DOOR SCHEDULE										
	DOOR						DETAIL			
NUMBER	WIDTH	HEIGHT	THICKNESS	MATERIAL	MATERIAL	HARDWARE	SILL	JAMB	HEAD	NOTES
W101A	3'-0"	7'-0"	1 3/4"	FRP2	FRP2	3.0		3 & 12/WA3.0	3/WA3.0 SIM	INSULATED, PROVIDE WEATHERSTRIPPING AROUND DOOR
W101B	3'-0"	7'-0"	1 3/4"	FRP2	FRP2	3.0		3 & 12/WA3.0	3/WA3.0 SIM	INSULATED, PROVIDE WEATHERSTRIPPING AROUND DOOR
W101C	16'-0"	12'-0"	1 3/4"	STEEL	STEEL	4.0		3/WA3.0	4/WA3.0	INSULATED, PROVIDE WEATHERSTRIPPING AROUND DOOR
W101D	16'-0"	12'-0"	1 3/4"	STEEL	STEEL	4.0		3/WA3.0	4/WA3.0	INSULATED, PROVIDE WEATHERSTRIPPING AROUND DOOR

MATE	RIAL SCHEDULE			
MARK	MATERIAL	MFR	STYLE / COLOR	NOTES
HC2	HARDENED CONCRETE	CONVERGENT CONCRETE TECHNOLOGIES	PENTRA-SIL 244+	LOCATED ON SLAB IN WASH BAY AND SHED
MP1	MTL WALL PANEL	PEMB MFR	SIM TO: PATINA GREEN - R PANEL (1.25") 26 GA.	METAL WALL PANELS OVER WAINSCOT
MP2	MTL WALL PANEL	PEMB MFR	SIM TO: CHARCOAL GRAY - R PANEL (1.25") 26 GA.	METAL WALL PANELS UNDER WAINSCOT
MP3	MTL WALL PANEL	PEMB MFR	WHITE FLUROPON - R PANEL (1.25") 24 GA.	METAL WALL PANELS INTERIOR
MP4	MTL SOFFIT PANEL	PEMB MFR	WHITE FLUROPON - 12" FLAT PANEL (1") 24 GA.	SOFFT PANELS
RP1	MTL ROOF PANEL	PEMB MFR	WHITE FLUROPON - R PANEL (1.25") 24 GA.	ROOF PANELS
FRP2	FIBER REINFORCED PLASTIC	SPECIAL-LITE	WHITE, AF-217 PEBBLE GRAIN	LOCATED AT FRP MAN-DOORS
PVC1	POLYVINYL CHLORIDE	TRUSSCORE	WHITE	
PT5	PAINT 5	SHERWIN WILLIAMS	SW6910 DAISY	LOCATED ON ALL BOLLARDS & HOIST LETTERS
PT6	PAINT 6	SHERWIN WILLIAMS	B42W01181	ALL EXPOSED STEEL TO BE PAINTED PT6, U.N.O.

NOTE: RAKE TRIM, RIDGE CAP & GUTTERS TO MATCH RP1 / MP4, DOWNSPOUTS TO MATCH MP1, WAINSCOT TRIM TO MATCH MP2. ALL BY PEMB MFR.

INTERNATIONAL BUILDING CODE 2018 INTERNATIONAL FIRE CODE 2018 INTERNATIONAL FUEL GAS CODE 2018 INTERNATIONAL MECHANICAL CODE 2018 INTERNATIONAL PLUMBING CODE 2018 NATIONAL ELECTRICAL CODE 2017 AMERICAN WITH DISABILITIES ACT 2010

CODE ANALYSIS

PRE-ENGINEERED METAL BUILDING USED FOR OPEN-AIR EQUIPMENT STORAGE AND AN ENCLOSED WASH BAY.

# CONSTRUCTION TYPE:

II-B ( SECTION 602.2) NOT SPRINKLERED

STRUCTURE DESCRIPTION:

APPLICABLE CODES:

## OCCUPANCY TYPE:

U (SECTION 312)

# ALLOWABLE BUILDING SIZE:

HEIGHT (U): STORIES (Ú): AREA (U): 8,500 SF


# ACTUAL BUILDING SIZE:

HEIGHT: 20'-4" STORIES: 7,182 SF AREA:

# FIRE RESISTANCE RATING REQUIREMENTS (SECTION 601):

PRIMARY STRUCTURAL FRAME: 0 HR EXTERIOR BEARING WALLS: 0 HR INTERIOR BEARING WALLS: 0 HR EXTERIOR NONBEARING WALLS & PARTITIONS: 0 HR INTERIOR NONBEARING WALLS & PARTITIONS: 0 HR FLOOR CONST. & SECONDARY MEMBERS: 0HR ROOF CONST. & SECONDARY MEMBERS: 0HR 


### MONITORED FIRE ALARM REQUIRED AND IS PROVIDED. Junium mining

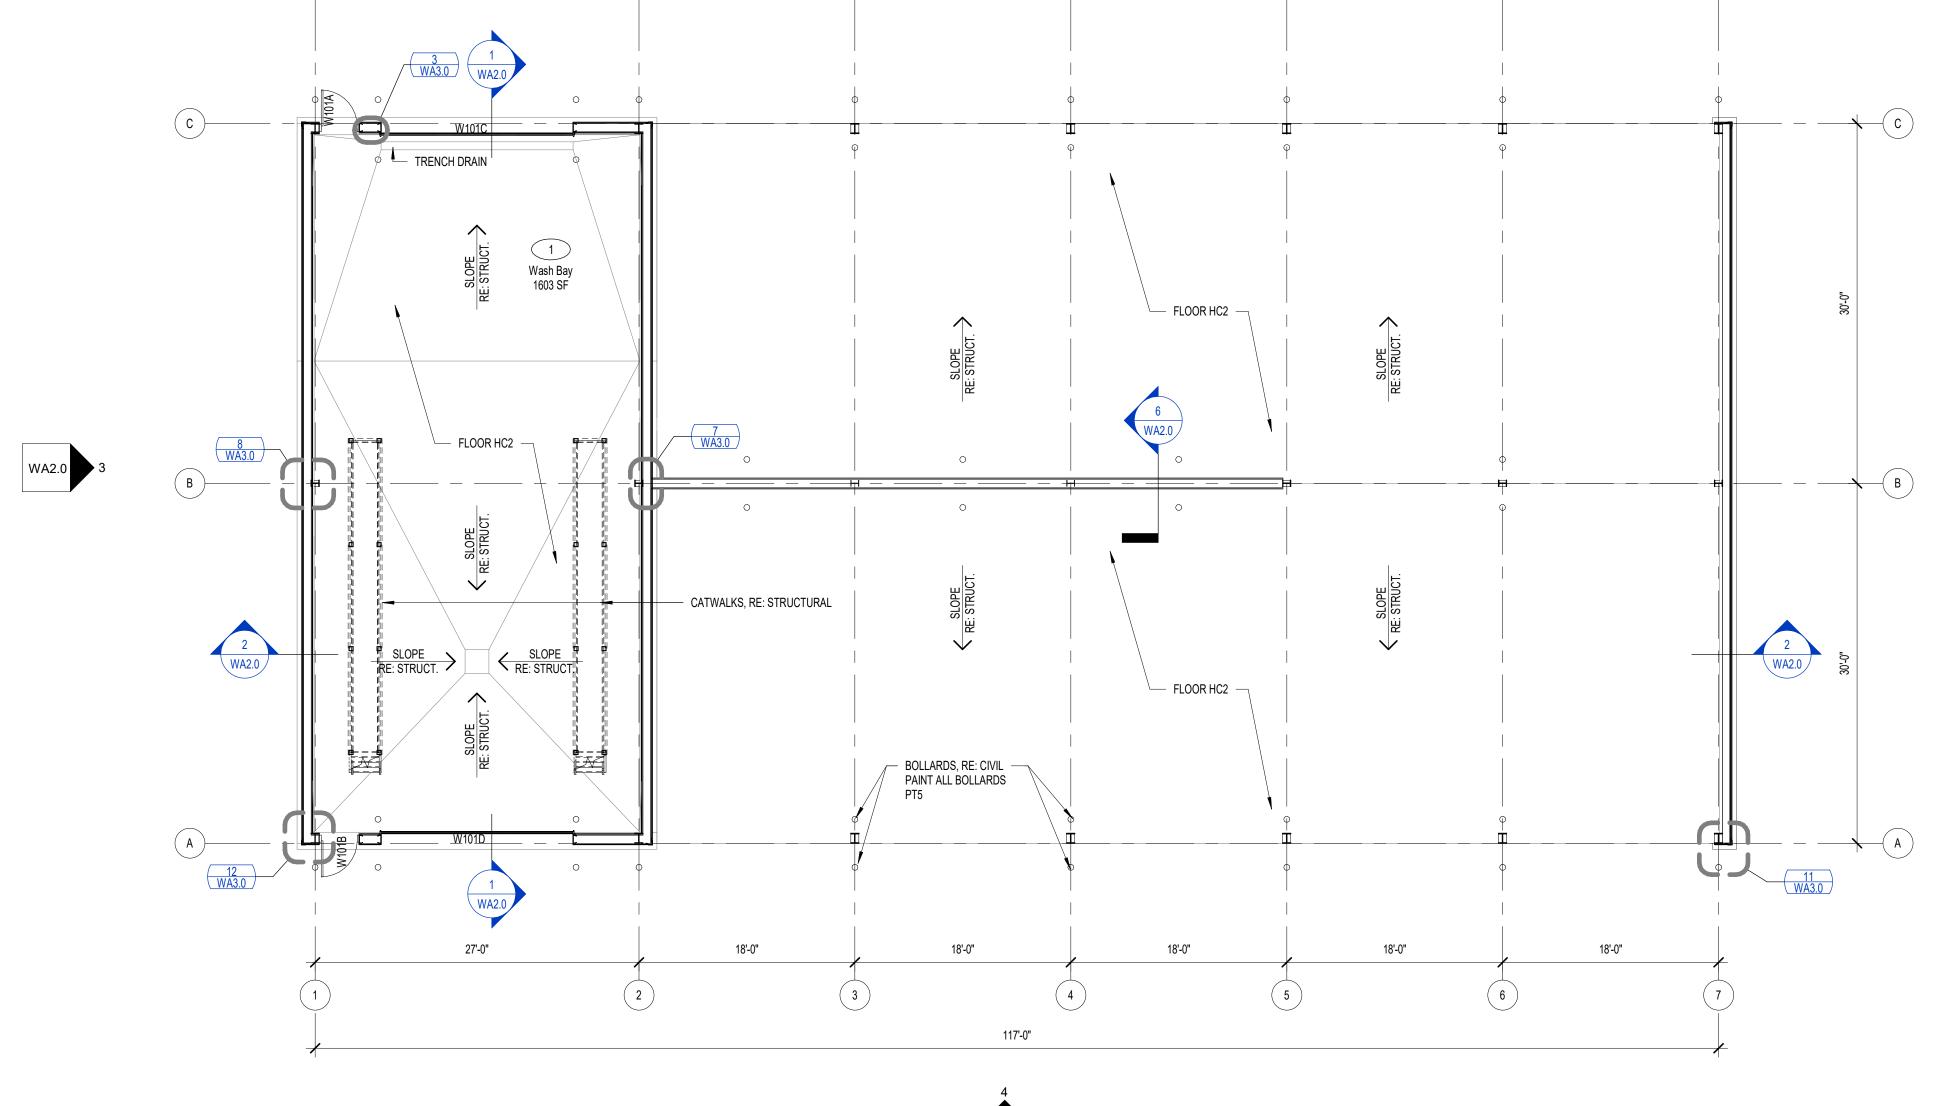


1 FLOOR PLAN
1/8" = 1'-0"





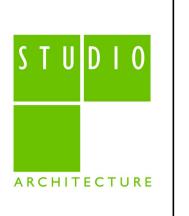

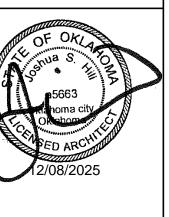

SUBMITTAL:	CONSTRUCTION DOCUMENTS		REVISION HISTORY	
DATE:	08/08/2025	ON.	NO. DESCRIPTION	ITAO
PROJECT NO: 240622	240622	1	ADDENDUM NO 1	12/02/20
DESIGNED BY:				
DRAWN BY:	DCL			
APPROVED BY:   JSH	JSH			
SCALE:	AS INDICATED			

MAINTENANCE FACILITY
DISTRICT 2 - BRYAN COUNTY
KLAHOMA DEPARTMENT OF TRANSPORTATION


SHEET NAME FLOOR PLAN

SHEET WA1.0

INPUT CAPACITY (BTUH)	FUEL	SERVES	MOUNTING / MOUNTING ANGLE	MOUNTING HEIGHT (FT)	OVERALL LENGTH (FT)	VOLTS / PHASE	AMPS	MFG	MODEL	NOTES
80,000	PROP.	SHOP BAY	CEILING SUSPENDED / 45°	NOTE 2	21	120/1	1.5	SCHWANK	S100 80-20	1,2
80,000	PROP.	SHOP BAY	CEILING SUSPENDED / 45°	NOTE 2	21	120/1	1.5	SCHWANK	S100 80-20	1,2
80,000	PROP.	SHOP BAY	CEILING SUSPENDED / 45°	NOTE 2	21	120/1	1.5	SCHWANK	S100 80-20	1,2
80,000	PROP.	SHOP BAY	CEILING SUSPENDED / 45°	NOTE 2	21	120/1	1.5	SCHWANK	S100 80-20	1,2
	CAPACITY (BTUH)  80,000  80,000  80,000	CAPACITY (BTUH)  80,000 PROP.  80,000 PROP.	CAPACITY (BTUH)         80,000         PROP.         SHOP BAY           80,000         PROP.         SHOP BAY           80,000         PROP.         SHOP BAY	CAPACITY (BTUH)  80,000  PROP. SHOP BAY  CEILING SUSPENDED / 45°  80,000  PROP. SHOP BAY  CEILING SUSPENDED / 45°  SUSPENDED / 45°  CEILING SUSPENDED / 45°  SUSPENDED / 45°  SUSPENDED / 45°  SUSPENDED / 45°  SUSPENDED / 45°	CAPACITY (BTUH)  80,000  PROP. SHOP BAY  CEILING SUSPENDED / 45°  NOTE 2  80,000  PROP. SHOP BAY  CEILING SUSPENDED / 45°  NOTE 2  80,000  PROP. SHOP BAY  CEILING SUSPENDED / 45°  NOTE 2  80,000  PROP. SHOP BAY  CEILING SUSPENDED / 45°  NOTE 2  80,000  PROP. SHOP BAY  CEILING SUSPENDED / 45°  NOTE 2	CAPACITY (BTUH)         MOUNTING ANGLE         HEIGHT (FT)         LENGTH (FT)           80,000         PROP.         SHOP BAY         CEILING SUSPENDED / 45°         NOTE 2         21           80,000         PROP.         SHOP BAY         CEILING SUSPENDED / 45°         NOTE 2         21           80,000         PROP.         SHOP BAY         CEILING SUSPENDED / 45°         NOTE 2         21           80,000         PROP.         SHOP BAY         CEILING NOTE 2         21	CAPACITY (BTUH)         MOUNTING ANGLE         HEIGHT (FT)         LENGTH (FT)         / PHASE           80,000         PROP.         SHOP BAY         CEILING SUSPENDED / 45°         NOTE 2         21         120/1           80,000         PROP.         SHOP BAY         CEILING SUSPENDED / 45°         NOTE 2         21         120/1           80,000         PROP.         SHOP BAY         CEILING SUSPENDED / 45°         NOTE 2         21         120/1           80,000         PROP.         SHOP BAY         CEILING         NOTE 2         21         120/1	CAPACITY (BTUH)         MOUNTING ANGLE         HEIGHT (FT)         LENGTH (FT)         / PHASE           80,000         PROP.         SHOP BAY         CEILING SUSPENDED / 45°         NOTE 2         21         120/1         1.5           80,000         PROP.         SHOP BAY         CEILING SUSPENDED / 45°         NOTE 2         21         120/1         1.5           80,000         PROP.         SHOP BAY         CEILING SUSPENDED / 45°         NOTE 2         21         120/1         1.5           80,000         PROP.         SHOP BAY         CEILING         NOTE 2         21         120/1         1.5	CAPACITY (BTUH)         MOUNTING ANGLE         HEIGHT (FT)         LENGTH (FT)         / PHASE           80,000         PROP.         SHOP BAY         CEILING SUSPENDED / 45°         NOTE 2         21         120/1         1.5         SCHWANK           80,000         PROP.         SHOP BAY         CEILING SUSPENDED / 45°         NOTE 2         21         120/1         1.5         SCHWANK           80,000         PROP.         SHOP BAY         CEILING SUSPENDED / 45°         NOTE 2         21         120/1         1.5         SCHWANK           80,000         PROP.         SHOP BAY         CEILING         NOTE 2         21         120/1         1.5         SCHWANK	CAPACITY (BTUH)

PROVIDE COMBUSTION AIR DUCT AND GAS FLUE ROOF TERMINATIONS, HEAT REFLECTORS, AND DEDICATED THERMOSTAT. INSTALL WITH HARDWIRED POWER CONNECTIONS (REF ELECTRICAL PLANS). COMPLY WITH MANUFACTURER RECOMMENDED CLEARANCES AND INSTALLATION INSTRUCTIONS.
 MAXIMIZE UNIT HEIGHT WITHIN SPACE, WHILE MAINTAINING ALL CLEARANCE REQUIREMENTS WITH BUILDING COMPONENTS, LIGHTING, DOORS, ETC. APPROXIMATE MOUNTING HEIGHT IS 13 FEET A.F.F.

NOTE: EQUIPMENT ON THIS SHEET HAS BEEN USED AS THE BASIS OF DESIGN. COMPETITIVE BIDDING IS DESIRED. ALL EQUIPMENT SUBSTITUTIONS WILL BE SUBJECT TO OWNER/ARCHITECT/ENGINEER SUBMITTAL REVIEW PROCESS TO DETERMINE AS EQUAL.

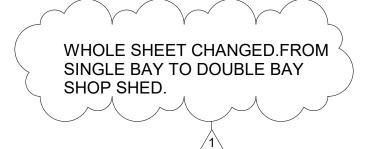

VENT	FILATION I	EQUIPMEN	T SCHEDU	JLE						
MARK	SERVES	AIR FLOW	ESP	MOUNTING	ELECTRICAL D	DATA	DRIVE	MFG	MODEL	NOTES
		RATE (CFM)	(IN-WG)		POWER (HP)	VOLTS/ PHASE				
EF-E1	SHOP BAY	5432	0.3	WALL	3/4	115/1	BELT	GREENHECK	SBE-3H30	1,2,3
EF-E2	SHOP BAY	5432	0.3	WALL	3/4	115/1	BELT	GREENHECK	SBE-3H30	1,2,3

# NOTES:

1. FAN SHALL BE INSTALLED WITH UNIT MOUNTED FAN SPEED CONTROLLER.

2. PROVIDE MANUAL WALL SWITCH FOR FAN ACTIVATION AT LOCATION DETERMINED BY OWNER.

3. PROVIDE WITH FACTORY FURNISHED GRAVITY BACKDRAFT DAMPER, WALL COLLAR, MOTOR SLIDE GUARD, AND 45° WEATHERHOOD.

# LOUVER SCHEDULE


MARK	MFG	MODEL NO.	TYPE	MOUNTING	NOMINAL SIZE (W"XH")	FREE AREA (SQ. FT.)	PRESSURE DROP (IN. WG)	DAMPER	NOTES
LV-E1	GREENHECK	ESD-603	INTAKE	WALL	36X36	4.34	0.04	MOTOR OPERATED	1,2,3
LV-E2	GREENHECK	ESD-603	INTAKE	WALL	36x36	4.34	0.04	MOTOR OPERATED	1,2,3
LV-E3	GREENHECK	ESD-603	INTAKE	WALL	36x36	4.34	0.04	MOTOR OPERATED	1,2,3
LV-E4	GREENHECK	ESD-603	INTAKE	WALL	36x36	4.34	0.04	MOTOR OPERATED	1,2,3

### NOTES:


1. LOUVER CONSTRUCTION SHALL BE EXTRUDED ALUMINUM WITH DRAINABLE FIXED BLADES. PROVIDE LOUVER WITH BIRD SCREEN AND MOUNTING FRAME SUITABLE FOR INTENDED INSTALLATION. LOUVER SHALL HAVE A FACTORY KYNAR 500 FINISH, COLOR TO MATCH EXTERIOR OF METAL BUILDING SIDING, REFER TO ARCHITECTURAL FOR APPROVED COLORS.


2. PROVIDE MOTOR OPERATED DAMPER AND INTERLOCK EF-E1 TO LV-E1 AND LV-E2, AND INTERLOCK EF-E2 WITH LV-E3 AND LV-E4.

3. FINAL LOUVER DIMENSIONS SHALL COURSE WITH ACTUAL WALL/BRICK CONFIGURATION (IF THAT CONDITION EXISTS), CONCRETE PANEL, AND/OR WINDOW OPENINGS. COORDINATE LOUVER SIZES WITH OTHER TRADES PRIOR TO ORDERING UNITS.

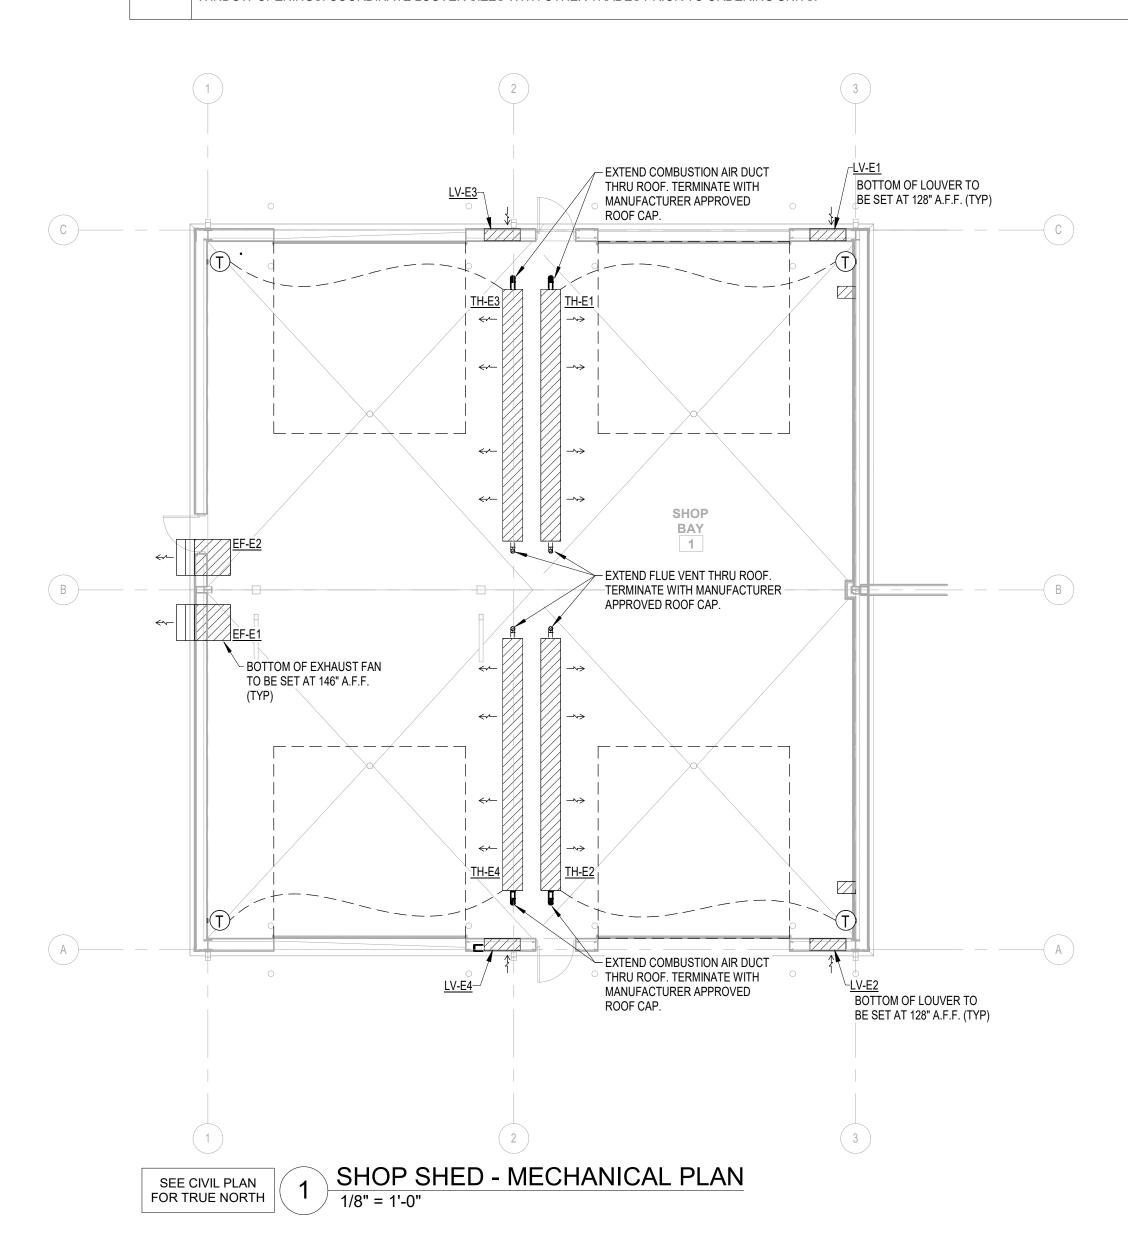

CEC CORPORATION WWW.CONNECTCEC.COM OK CA#: 32 EXP.: 2026 -06-30

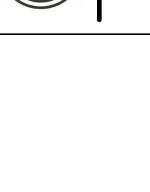

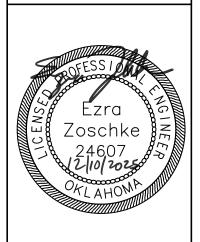

STRUCTION JMENTS		REVISION HISTORY	
//2025	Ö	NO. DESCRIPTION	DATE
22	-	ADEDNDUM #1	12/10/20
IDICATED			

SUBMITTAL: CONSTRUCTION DOCUMENTS
DATE: 08/08/2025
PROJECT NO: 240622
DESIGNED BY: EDZ
DRAWN BY: BAH
APPROVED BY: EDZ

MAINTENANCE FACILITY

DISTRICT 2 - BRYAN COUNTY
HOMA DEPARTMENT OF TRANSPORTATION

MA

SHOP SHED MECHANICAL PLAN

SHEET

EM1.0

# WATER HEATER SCHEDULE

	FLC	W RATE			INPUTS	3	
MARK	GPM	RISE (°F)	STORAGE (GAL.)	KW	AMP	VOLTS/ PHASE	REMARKS
EWH-E1	7.0	25	N/A	18	75	240/1	EEMAX PROSERIES MODEL PR018240; INTERNAL TEMPERATURE CONTROL, COPPER IMMERSION HEATING ELEMENTS WITH BRASS TOP.
1		1	1		1		

# OWNER PROVIDED EQUIPMENT LIST

O WITE IN THE	
AIR COMPRESSOR	CONTRACTOR INSTALLED; QUINCY MODEL QT-54, 5 HP TANK MOUNTED RECIPROCATING COMPRESSORS, OR EQUAL. SPLASH LUBRICATED 2-STAGE RECIPROCATING COMPRESSORS RATED AT 15.2 ACFM AT 175 PSIG; 60 GALLON TANK; ADJUST PRESSURE SETTING AT 125 PSIG; PROVIDE QT PRO PACKAGE 2V41C60VC AND NO BULL 2 YEAR WARRANTY, OR EQUAL; 220V/1 PH, 24 AMP DRAW, 50 AMP BREAKER.
COMPRESSED AIR HOSE REEL	CONTRACTOR INSTALLED;COXREEL EZ-EN-450, OR EQUAL. 50' HOSE, 1/2 " ID; 300 PSI WITH HOSE STOP; SWING BRACKET AND QUICK DISCONNECT. CONNECT HOSE REEL TO <u>CAD-01</u> ; REFER TO PLUMBING FIXTURE SCHEDULE FOR ADDITIONAL INFORMATION.

WASTE-OIL TANK | CONTRACTOR INSTALLED; SNYDER 5740102N95703 275 GALLON USED OIL COLLECTION TANK, OR EQUAL. PROVIDE

SEE CIVIL PLAN FOR TRUE NORTH

NOTE: EQUIPMENT ON THIS SHEET HAS BEEN USED AS THE BASIS OF DESIGN. COMPETITIVE BIDDING IS DESIRED. ALL EQUIPMENT SUBSTITUTIONS WILL BE SUBJECT TO OWNER/ARCHITECT/ENGINEER SUBMITTAL REVIEW PROCESS TO DETERMINE AS EQUAL.


OPTIONAL LEVEL GAUGE/TANK LEVEL INDICATOR.

# PLUMBING FIXTURE SCHEDULE

MARK	TYPE	MOUNTING	WASTE	VENT	CW	HW	CA	MFG	MODEL	DESCRIPTION
EE-01	EMERGENCY EYEWASH	WALL	1-1/4"		1/2"	1/2"		BRADLEY	S19224B	SAFETY YELLOW COATED 1-1/4" GALVANIZED STEEL WALL BRACKET, TYPE 304 STAINLESS STEEL BOWL, 1/2 "STAY-OPEN CHROME PLATED BRASS EYEWASH BALL VALVE W/YELLOW TYPE 304 STAINLESS STEEL PUSH HANDLE, CHROME PLATED BRASS SOFT-FLOW EYEWASH SPRAY HEADS W/PROTECTIVE COVERS; PROVIDE NAVIGATOR S19-2000 EFX8 EMERGENCY THERMOSTATIC MIXING VALVE.
SK-04	SINGLE COMPARTMENT SHOP SINK	FLOOR	2"		1/2"	1/2"		EAGLE	314-24-1-24	14 GAUGE STAINLESS STEEL, 24"X24"X13-1/2" DEEP BOWL, (2)24" DRAINBOARDS EACH SIDE. PROVIDE WITH T & S BRASS B-0230-LN FAUCET W/10" SWING NOZZLE; (2) JUST J-35-BLA-2" DRAINS WITH TWIST HANDLES; CHROME PLATED TUBULAR BRASS WASTE PIPING AND FITTINGS TO DRAIN. PROVIDE QUARTER TURN WATER SUPPLY SHUT-OFF VALVES AND MOUNTING ACCESSORIES.
CAD-01	COMPRESSED AIR DROP	WALL	-				3/4"	WILKERSON	SEE NOTES	WILKERSON CB6-4-000 FILTER/REGULATOR; WILKERSON L28-04-KK00 LUBRICATOR, WILKERSON RPA-95-090 WALL BRACKET. INSTALL ON 3/4" PLYWOOD BACKING, PAINTED TO MATCH ADJACENT WALL. CONFIRM MOUNTING HEIGHT WITH OWNER PRIOR TO INSTALLATION. OWNER PROVIDED HOSE REEL TO BE INSTALLED AND CONNECTED; SEE OWNER PROVIDED EQUIPMENT LIST FOR HOSE REEL INFORMATION.
FD-01	FLOOR DRAIN	FLOOR	3"	2"				WADE	W1100-DA5	CAST IRON FLOOR DRAIN W/FLANGE, INTEGRAL REVERSIBLE CLAMPING COLLAR, SEEPAGE OPENINGS, PLUGGED PRIMER TAP, AND 6" DIAMETER NICKEL BRONZE STRAINER WITH VANDAL PROOF SCREWS. PROVIDE PRO VENT SYSTEMS TRAP GUARD, OR APPROVED EQUAL.
FD-02	FLOOR DRAIN - HEAVY DUTY GRATE	FLOOR	3"	2"				WADE	W1100-DA5-X	HEAVY DUTY RATED CAST IRON FLOOR DRAIN W/FLANGE, INTEGRAL REVERSIBLE CLAMPING COLLAR, SEEPAGE OPENINGS, PLUGGED PRIMER TAP, AND 6" DIAMETER NICKEL BRONZE STRAINER WITH VANDAL PROOF SCREWS. PROVIDE PRO VENT SYSTEMS TRAP GUARD, OR APPROVED EQUAL.
FS	FLOOR SINK	FLOOR	SEE PLANS	2"				WADE	W9150	CAST IRON 12" SQ FLOOR SINK WITH 10" SUMP, A.R.E. INTERIOR, ALUMINUM DOME STRAINER AND NICKEL BRONZE HINGED TOP, 3" OUTLET, INSTALL WITH PROVENT TRAP GUARD SEALING DEVICE, OR EQUAL.
FCO-01	FLOOR CLEAN OUT	FLOOR	4"		-			WADE	6000	PROVIDE ABS TAPERED THREAD PLUG & VANDAL PROOF CLOSURES AND INSTALL IN THICKENED SLAB IN INTERIOR LOCATIONS.
FCO-02	FLOOR CLEAN OUT - HEAVY DUTY COVER	FLOOR	4					WADE	6000X	PROVIDE ABS TAPERED THREAD PLUG & VANDAL PROOF CLOSURES AND INSTALL IN THICKENED SLAB IN INTERIOR LOCATIONS. PROVIDE WITH HEAVY-DUTY X MODEL FOR GARAGE LOCATIONS.
YCO-02	YARD CLEAN OUT - HEAVY DUTY COVER	FINISH GRADE	4"					WADE	6000X	PROVIDE ABS TAPERED THREAD PLUG & VANDAL PROOF CLOSURES. PROVIDE MIN. 18"X18"X6" DEEP CONCRETE PAD/BLOCK FOR 2-WAY EXTERIOR LOCATIONS PROVIDE WITH HEAVY-DUTY X MODEL WITH BRONZE PLUG FOR EXTERIOR LOCATIONS.
НВ	HOSE BIB	WALL		-	1/2"			WOODFORD	24	ANTI-SIPHON, VACUUM BREAKER PROTECTED FAUCET.
FPWH	FREEZE PROOF WATER HYDRANT	WALL			3/4"			WOODFORD	B65	FREEZELESS WALL HYDRANT WITH VACUUM BREAKER AND KEY OPERATION.
OT-E1	OIL TRAP	FLOOR	4"	3"				SCHIER	OS-50	POLYETHYLENE MOLDED, 57 GALLON CAPACITY, 50 GPM MAX FLOW RATE. PROVIDE WITH FIELD ADJUSTABLE RISERS AS REQUIRED TO INSTALL FLUSH WITH FINISH FLOOR, AND 16,000 lbs HEAVY DUTY HIGHWAY RATED COVER. INSTALL PER MANUFACTURER'S REQUIREMENTS.

1. EQUIPMENT SCHEDULED IS BASIS OF DESIGN. PROPOSED FIXTURES TO BE SUBSTITUTED BY CONTRACTOR WILL BE SUBJECT TO OWNER/ENGINEER/ARCHITECT SUBMITTAL REVIEW AND WRITTEN APPROVAL PROCESS.


SEE CIVIL PLAN FOR TRUE NORTH 2

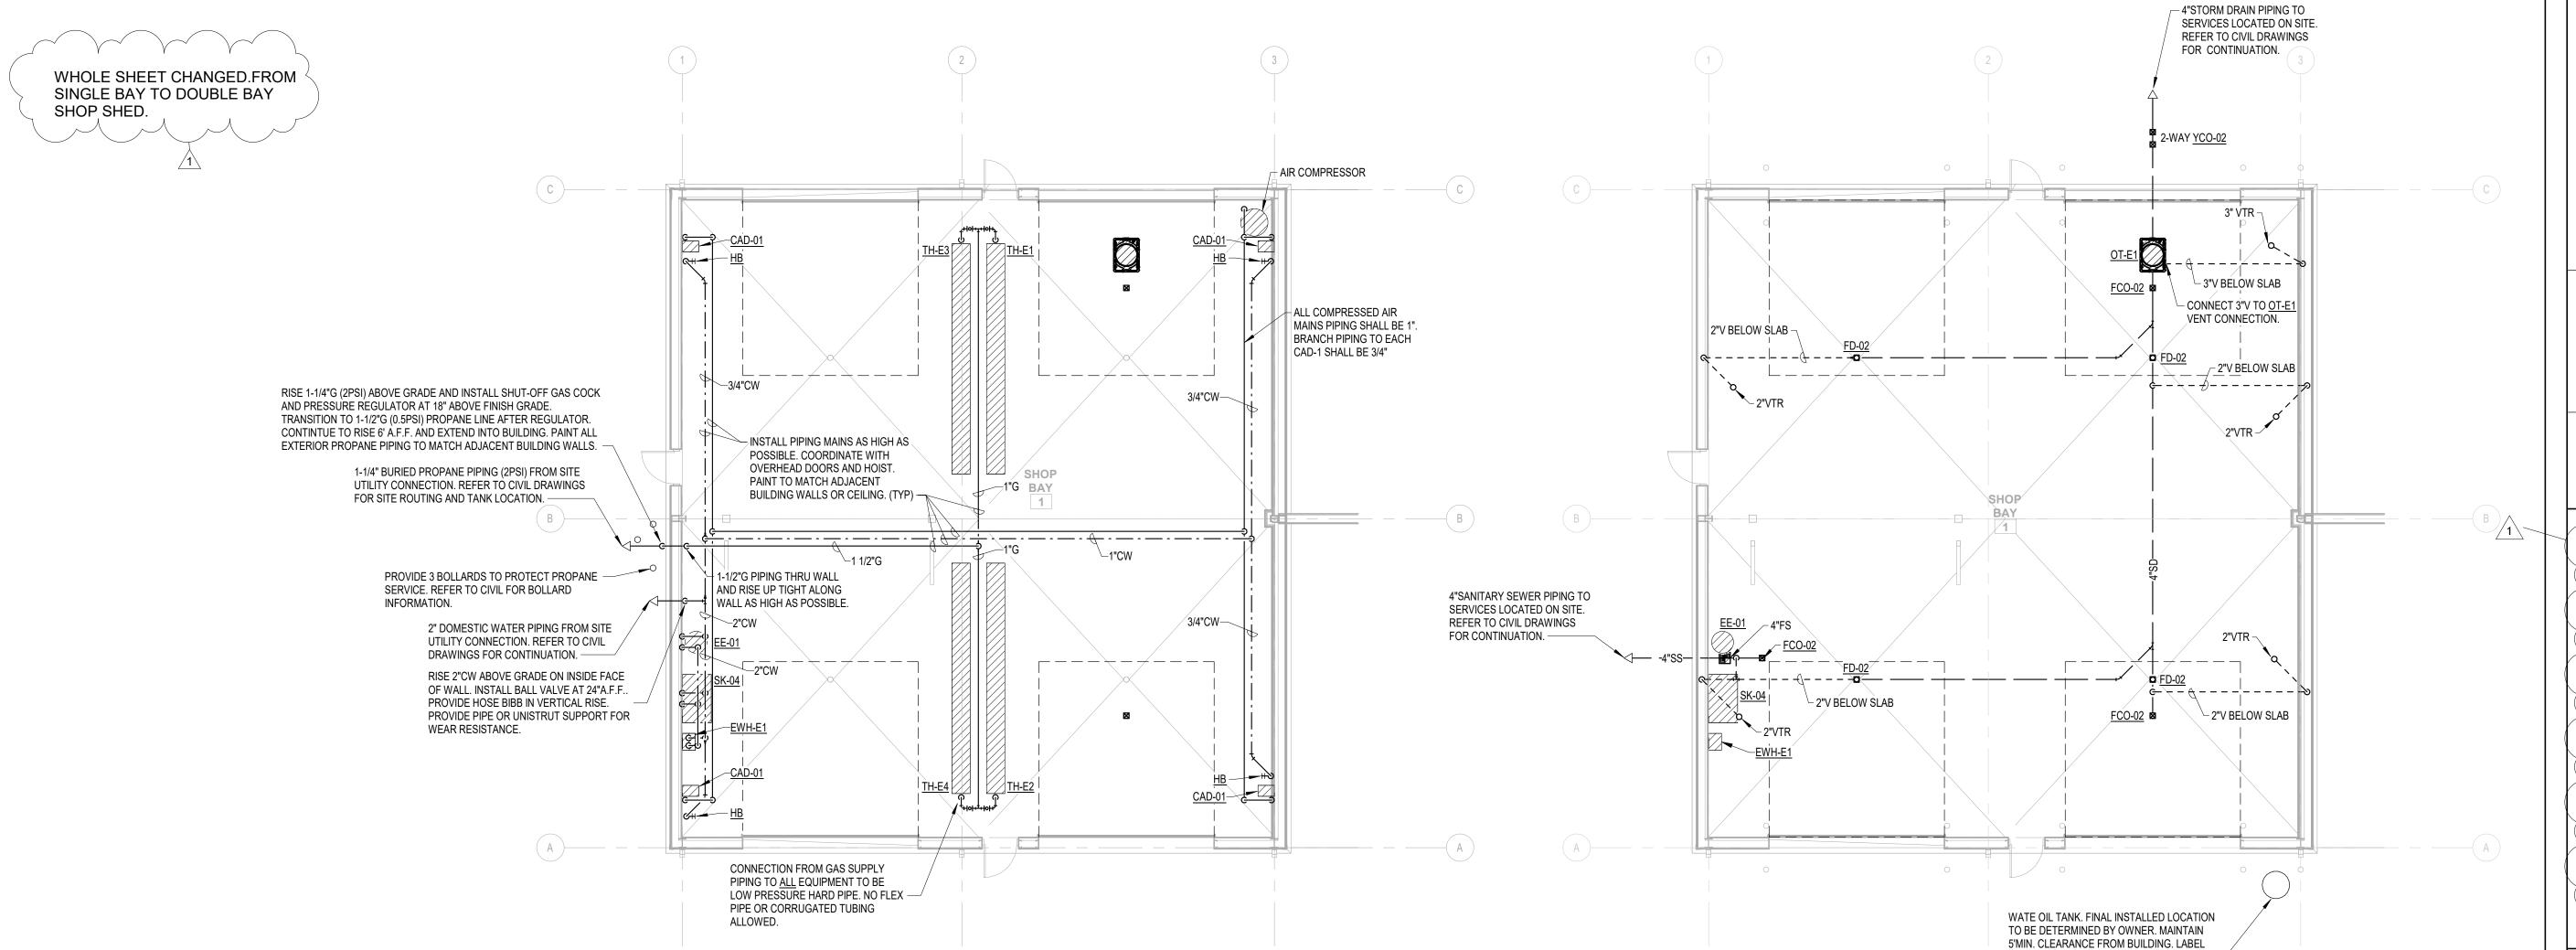

SHOP SHED - PLUMBING DOMESTIC WATER & GAS PLAN

CEC®

O CEC CORPOR

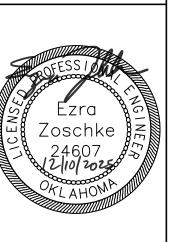

 CONSTRUCTION
 REVISION HISTORY

 DOCUMENTS
 NO. DESCRIPTION
 DATE

 240622
 1 ADEDNDUM #1
 12/10/2025

 EDZ
 BAH
 12/10/2025

 AS INDICATED
 AS INDICATED
 12/10/2025

NANCE FACILITY
T 2 - BRYAN COUNTY
STMENT OF TRANSPORTATION

MAINTENANCE F
DISTRICT 2 - BRYAN (
OKLAHOMA DEPARTMENT OF T

SHOP SHED PLUMBING PLANS

PER TANK CODE. (TYP OF 2) -

SHOP SHED - PLUMBING WASTE-VENT PLAN

SHEET

EP1.0


MARK	INPUT CAPACITY (BTUH)	FUEL	SERVES	MOUNTING / MOUNTING ANGLE	MOUNTING HEIGHT (FT)	OVERALL LENGTH (FT)	VOLTS / PHASE	AMPS	MFG	MODEL	NOTES
TH-W1	80,000	PROP.	WASH BAY	CEILING SUSPENDED / 0°	NOTE 3	21	120/1	1.5	SCHWANK	SPW-JS-80-20	1,2,3
TH-W2	80,000	PROP.	WASH BAY	CEILING SUSPENDED / 0°	NOTE 3	21	120/1	1.5	SCHWANK	SPW-JS-80-20	1,2,3

1. PROVIDE COMBUSTION AIR DUCT AND GAS FLUE ROOF TERMINATIONS, HEAT REFLECTORS, AND DEDICATED THERMOSTAT. INSTALL WITH HARDWIRED POWER CONNECTIONS (REF ELECTRICAL PLANS). COMPLY WITH MANUFACTURER RECOMMENDED CLEARANCES AND INSTALLATION INSTRUCTIONS.

2. PROVIDE SCHWANK JS-0570-XX NEMA 4X RATED THERMOSTAT.


3. MAXIMIZE UNIT HEIGHT WITHIN SPACE, WHILE MAINTAINING ALL CLEARANCE REQUIREMENTS WITH BUILDING COMPONENTS, LIGHTING, DOORS, ETC. APPROXIMATE HEIGHT IS 13 FEET A.F.F..

> NOTE: EQUIPMENT ON THIS SHEET HAS BEEN USED AS THE BASIS OF DESIGN. COMPETITIVE BIDDING IS DESIRED. ALL EQUIPMENT SUBSTITUTIONS WILL BE SUBJECT TO OWNER/ARCHITECT/ENGINEER SUBMITTAL REVIEW PROCESS TO DETERMINE AS EQUAL.

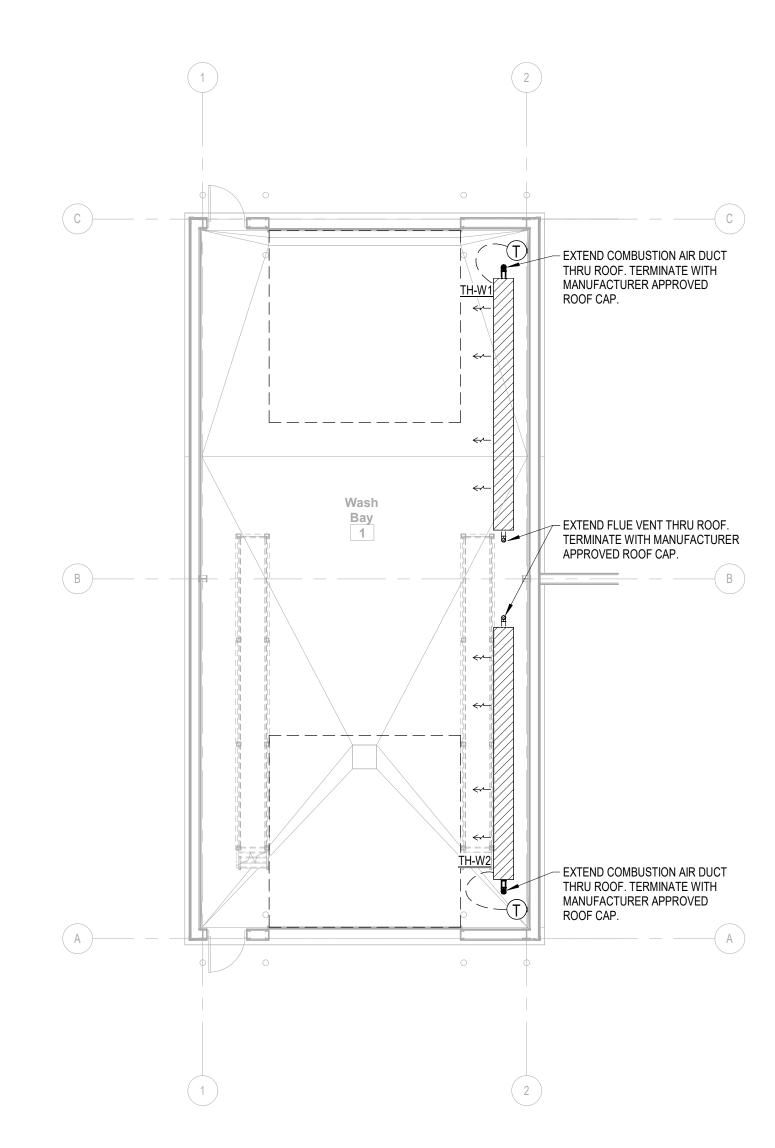

SEE CIVIL PLAN FOR TRUE NORTH

1 WASH SHED - MECHANICAL PLAN 1/8" = 1'-0"

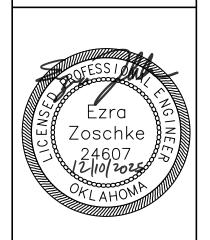

TTAL:	CONSTRUCTION DOCUMENTS		REVISION HISTORY	
	08/08/2025	ŏ.	NO. DESCRIPTION	۵
CT NO: 240622	240622	1	ADDENDUM #1	12/1(
NED BY:   EDZ	EDZ			
N BY:	ВАН			
OVED BY: EDZ	EDZ			
	AS INDICATED			

MAINTENANCE FACILITY

WASH SHED MECHANICAL PLAN

SHEET WM1.0

# OWNER PROVIDED EQUIPMENT LIST

WASHER


LANDA MODEL #MHC3-30324, OR EQUAL. WATER PORTABLE POWER WASHER, GASOLINE-POWERED, DIESEL-HEATED, CAPABLE OF 3.0GPM AT 3000 PSI, . INCLUDE 50' X 1/2" X 5000 PSI HP HOSE, VARIABLE PRESSURE DUAL LANCE WAND WITH TRIGGER GUN CONTROL AND FLOAT TANK AND INLET DETERGENT VALVE. ALSO INCLUDE 50' X 3/8" COMMERCIAL GRADE REINFORCED RUBBER HOSE (BLACK). PROVIDE A 10"X14" VINYL SIGN READING: "WARNING - DO NOT OPERATE MACHINERY INSIDE WITHOUT VENTILATING TO OUTSIDE".

> NOTE: EQUIPMENT ON THIS SHEET HAS BEEN USED AS THE BASIS OF DESIGN. COMPETITIVE BIDDING IS DESIRED. ALL EQUIPMENT SUBSTITUTIONS WILL BE SUBJECT TO OWNER/ARCHITECT/ENGINEER SUBMITTAL REVIEW PROCESS TO DETERMINE AS EQUAL.

PLUMBING FIXTURE SCHEDULE MODEL DESCRIPTION TYPE MOUNTING WASTE VENT FLOOR DRAIN FLOOR WADE W1100-DA5 CAST IRON FLOOR DRAIN W/FLANGE. INTEGRAL REVERSIBLE CLAMPING COLLAR, SEEPAGE OPENINGS. PLUGGED PRIMER TAP, AND 6" DIAMETER NICKEL BRONZE STRAINER WITH VANDAL PROOF SCREWS, PROVIDE PRO VENT SYSTEMS TRAP GUARD, OR APPROVED EQUAL. HEAVY DUTY RATED CAST IRON FLOOR DRAIN W/FLANGE, INTEGRAL REVERSIBLE CLAMPING COLLAR, SEEPAGE FLOOR DRAIN -FLOOR W1100-DA5-X OPENINGS. PLUGGED PRIMER TAP, AND 6" DIAMETER NICKEL BRONZE STRAINER WITH VANDAL PROOF SCREWS. HEAVY DUTY GRATE PROVIDE PRO VENT SYSTEMS TRAP GUARD, OR APPROVED EQUAL. CAST IRON 12" SQ FLOOR SINK WITH 10" SUMP. A.R.E. INTERIOR. ALUMINUM DOME STRAINER AND NICKEL FLOOR SINK FLOOR SEE WADE W9150 BRONZE HINGED TOP, 3" OUTLET, INSTALL WITH PROVENT TRAP GUARD SEALING DEVICE, OR EQUAL. PLANS FLOOR CLEAN OUT FLOOR WADE PROVIDE ABS TAPERED THREAD PLUG & VANDAL PROOF CLOSURES AND INSTALL IN THICKENED SLAB IN INTERIOR LOCATIONS. PROVIDE ABS TAPERED THREAD PLUG & VANDAL PROOF CLOSURES AND INSTALL IN THICKENED SLAB IN FLOOR CLEAN OUT -FLOOR WADE 6000X INTERIOR LOCATIONS. PROVIDE WITH HEAVY-DUTY X MODEL FOR GARAGE LOCATIONS. HEAVY DUTY COVER YCO-02 PROVIDE ABS TAPERED THREAD PLUG & VANDAL PROOF CLOSURES. PROVIDE MIN. 18"X18"X6" DEEP CONCRETE YARD CLEAN OUT -WADE 6000X GRADE PAD/BLOCK FOR 2-WAY EXTERIOR LOCATIONS PROVIDE WITH HEAVY-DUTY X MODEL WITH BRONZE PLUG FOR HEAVY DUTY COVER POLYDRAIN 6" WIDE POLYESTER POLYMER CONCRETE TRENCH DRAIN SYSTEM. TRENCH DRAIN TO BE SLOPED TO END DRAIN. TRENCH DRAIN -FLOOR 2" PROVIDE WITH CATCH BASIN AND SEDIMENT BUCKET AND 4"OUTLET. PROVIDE GRADE STYLE #502 SLOTTED DUCTILE HEAVY DUTY IRON GRATE WITH LOCKING DEVICES. INSTALLATION SHALL BE MY MANUFACTURER INSTRUCTIONS AND SHALL INCLUDE POLYCLIP INSTALLATION BRACKETS. INCLUDE MANUFACTURER SPECIFIC TRENCH SHOVEL FOR MAINTENANCE. AD-01 HEAVY DUTY 24"X24" AREA DRAIN WITH 4" OUTLET, GALVANIZED FINISH, ANCHOR FLANGE, ALUMINUM DOME STRAINER, AREA DRAIN -FLOOR 2" WADE 1890 STAINLESS STEEL PERFORATED SEDIMENT BUCKET. HEAVY DUTY ANTI-SIPHON, VACUUM BREAKER PROTECTED FAUCET. HOSE BIB 1/2" WOODFORD 24 **FPWH** FREEZE PROOF WALL 3/4" WOODFORD FREEZELESS WALL HYDRANT WITH VACUUM BREAKER AND KEY OPERATION. WATER HYDRANT OT-W1 OIL TRAP FLOOR SCHIER POLYETHYLENE MOLDED, 57 GALLON CAPACITY, 50 GPM MAX FLOW RATE. PROVIDE WITH FIELD ADJUSTABLE RISERS AS --REQUIRED TO INSTALL FLUSH WITH FINISH FLOOR, AND 16,000 lbs HEAVY DUTY HIGHWAY RATED COVER. INSTALL PER MANUFACTURER'S REQUIREMENTS.

1. EQUIPMENT SCHEDULED IS BASIS OF DESIGN. PROPOSED FIXTURES TO BE SUBSTITUTED BY CONTRACTOR WILL BE SUBJECT TO OWNER/ENGINEER/ARCHITECT SUBMITTAL REVIEW AND WRITTEN APPROVAL PROCESS

CONNECTION FROM GAS SUPPLY PIPING TO ALL **EQUIPMENT OT BE LOW** PRESSURE HARD PIPE. NO FLEX PIPE OR CORRUGATED - TUBING ALLOWED. RISE 1"G (2PSI) ABOVE GRADE AND INSTALL SHUT-OFF GAS COCK AND PRESSURE REGULATOR AT 18" ABOVE FINISH GRADE. TRANSITION TO 1-1/2"G (0.5PSI) PROPANE LINE AFTER REGULATOR CONTINUE TO RISE 6' A.F.F. AND EXTEND INTO BUILDING. PAINT ALL EXTERIOR PROPANE PIPING TO MATCH ADJACENT BUILDING WALLS. - INSTALL PROPANE PIPING AS HIGH AS 1" BURIED PROPANE PIPING (2PSI) FROM SITE POSSIBLE. COORDINATE WITH OVERHEAD UTILITY CONNECTION. REFER TO CIVIL DRAWINGS DOORS AND HOIST. PAINT TO MATCH FOR SITE ROUTING AND TANK LOCATION. -ADJACENT BUILDING WALLS OR CEILING. (TYP) `\_1 1/2"G 1-1/2"G PIPING THRU WALL AND RISE UP TIGHT ALONG PROVIDE 3 BOLLARDS TO PROTECT PROPANE WALL AS HIGH AS POSSIBLE. SERVICE. REFER TO CIVIL FOR BOLLARD INFORMATION. INSTALL 2" FILL VALVE WITH 2" CAMLOCK FIRE HOSE (25LF) WITH QUICK-CONNECT COUPLINGS. FINAL HOSE CONNECTION BURIED 2" NON-POTABLE WATER SUPPLY TO HYDRANT/FILL STATION ON TO BE APPROVED BY OWNER. MAINTAIN SITE. YARD HYDRANTS, WOODFORD MODEL Y2 OR APPROVED EQUAL, SUFFICIENT CLEARANCE FROM SHALL BE PROVIDED AND INSTALLED AT ALL LOCATIONS SHOWS ON CIVIL CATWALK SUPPORT FOR HOSE DRAWINGS. REFER TO CIVIL DRAWINGS FOR SITE ROUTING AND LOCATIONS. - CONNECTION USE. INSTALL 2" REDUCED PRESSURE PRINCIPLE BACKFLOW PREVENTER, APOLLO RP4A OR APPROVED EQUAL. - DROP 2"N.P. WATER SUPPORT PIPING FROM MULITPLE FLOOR BRACES TO SUPPLY UNDER SLAB. ENSURE RIGIDITY. REFER TO DETAIL 3 THIS SHEET. 2" DOMESTIC WATER SUPPLY FROM SITE UTILITY CONNECTION. REFER TO CIVIL DRAWINGS FOR CONTINUATION. HOSE BIBB INSTALLED SUCH THAT HOSE CONNECTION POINT IS FLUSH WITH SIDE OF CATWALK FOR EASE OF ACCESS. WOODFORD MODEL 24, OR EQUAL. - RISE 2" DOMESTIC WATER ABOVE GRADE. INSTALL BALL VALVE AT 24"A.F.F. SUPPORT PIPING FROM MULTIPLE FLOOR BRACES TO ENSURE RIGIDITY. ALL ABOVE GRADE PIPE TO BE TYPE K COPPER.

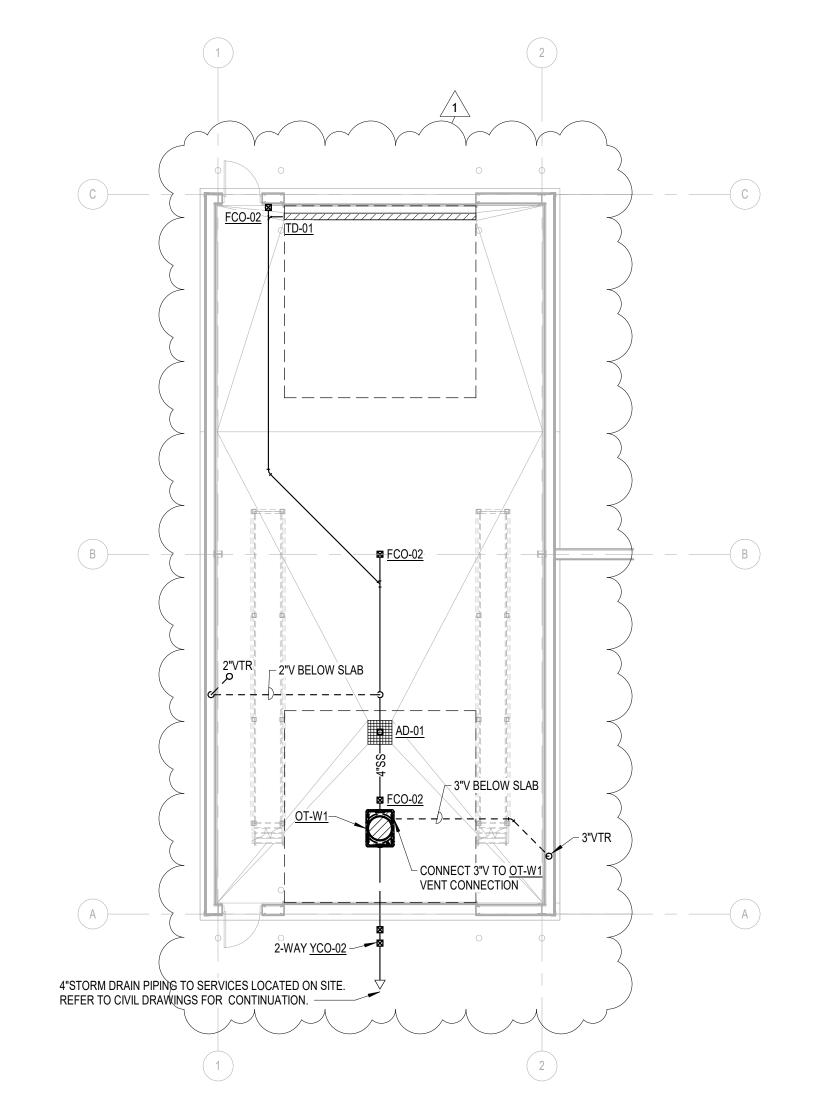

- 2" NON-POTABLE WATER DOWN TO UNDER SLAB. 2" CW RISER FROM - 3/4" HOSE BIBB UNDER SLAB. ---PLAN VIEW REDUCED PRESSURE BACKFLOW PREVENTER WITH 2" CAMLOCK FULL PORT BALL VALVES. -HOSE FITTING. PIPE OR UNISTRUT SUPPORTS ANCHORED TO FLOOR. (TYP.) -18" ABOVE UNION -FINISH FLOOR. -FINISHED FLOOR. **ELEVATION VIEW** 2" CW FROM 2" NON-POTABLE SERVICES ON SITE. WATER EXTENDED TO

3 BACKFLOW PREVENTER DETAIL

SEE CIVIL PLAN FOR TRUE NORTH

WASH SHED - PLUMBING DOMESTIC WATER & GAS PLAN

SEE CIVIL PLAN FOR TRUE NORTH 2 WASH SHED - PLUMBING WASTE-VENT PLAN 1/8" = 1'-0"

FACILI

SHEET NAME WASH SHED

PLUMBING PLANS

SHEET WP1.0