03/24/2023


FOR SURVEY CONTROL DATA, SEE SURVEY DATA SHEETS

STATE OF OKLAHOMA DEPARTMENT OF TRANSPORTATION

PLAN OF PROPOSED

MOORING MODERNIZATION

FEDERAL AID PROJECT NO. ####
MKARNS WATERWAY

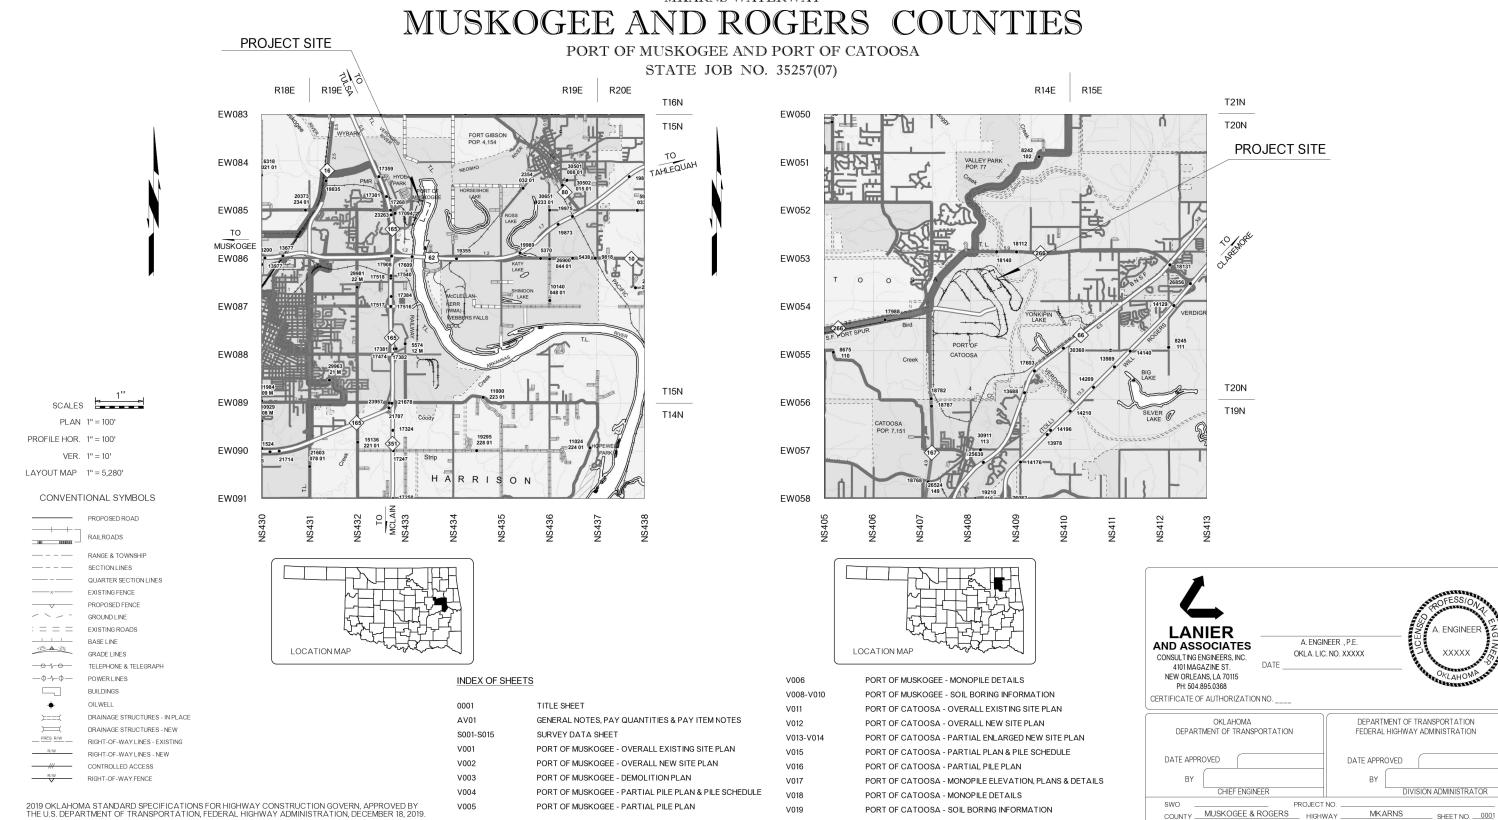

- CONSTRUCTION SHALL COMPLY WITH THESE GENERAL NOTES. THE CONTRACT DRAWINGS, SPECIFICATIONS, AND ALL APPLICABLE STATE AND
- EXISTING CONSTRUCTION AND CONDITIONS SHOWN ARE SCHEMATIC. ACTUAL CONDITIONS MAY DIFFER. CONTRACTOR IS FULLY RESPONSIBLE FOR MAKING THEIR OWN SITE EXAMINATION AND DETERMINING THE ACTUAL NATURE AND EXTENT OF EXISTING CONDITIONS AS NEEDED PRIOR TO UNDERTAKING THE WORK.
- U.S. ARMY CORPS OF ENGINEERS PERMITS HAVE BEEN SECURED BY THE OWNER. CONTRACTOR SHALL BE REQUIRED TO ABIDE BY ALL REQUIREMENTS AND RESTRICTIONS SET FORTH BY THESE PERMITS. ALL OTHER PERMITS. LICENSES AND NOTIFICATIONS NECESSARY FOR THE EXECUTION OF WORK SHALL BE SECURED BY THE CONTRACTOR
- ANY DAMAGE, DISTURBANCE, OR OTHER IMPAIRMENT OF EXISTING FACILITIES SHALL BE PROMPTLY REPAIRED OR REPLACED BY THE CONTRACTOR AS APPROVED BY AND AT NO ADDITIONAL COST TO THE OWNER.
- CONTRACTOR SHALL REMOVE CONSTRUCTION MATERIAL AND DEBRIS FROM THE WORK SITE DURING AND AT COMPLETION OF THE WORK.
- IT IS SOLELY THE CONTRACTOR'S RESPONSIBILITY TO FOLLOW ALL APPLICABLE SAFETY CODES, PERMIT RESTRICTIONS AND REGULATIONS DURING ALL PHASES OF CONSTRUCTION. CONTRACTOR IS RESPONSIBLE FOR SAFETY PRECAUTIONS, MEANS, METHODS, TECHNIQUES, SEQUENCES OR PROCEDURES REQUIRED FOR PERFORMANCE OF THE WORK INCLUDING, BUT NOT LIMITED TO, SHORING, SCAFFOLDING, UNDERPINNING AND ANY ERECTION
- ALL STRUCTURES ARE DESIGNED TO BE SELF-SUPPORTING AND STABLE AFTER ERECTION IS FULLY COMPLETED. IT IS SOLELY THE CONTRACTOR'S RESPONSIBILITY TO DETERMINE ERECTION PROCEDURE AND SEQUENCE AND TO ENSURE THE SAFETY OF THE STRUCTURE AND ITS COMPONENTS DURING ERECTION. THIS INCLUDES THE ADDITION OF ANY SHORING, SHEETING, TEMPORARY BRACING, GUYS, OR TIE DOWNS WHICH MIGHT BE NECESSARY. SUCH MATERIAL SHALL REMAIN THE CONTRACTOR'S PROPERTY AFTER COMPLETION OF THE PROJECT.
- CONTRACTOR WILL BE RESPONSIBLE FOR ALL LAYOUT AND SURVEYING REQUIRED FOR THE CONSTRUCTION AS SHOWN ON THE DRAWINGS.
- ALL EXISTING DIMENSIONS AND ELEVATIONS SHOWN ON DRAWINGS SHALL BE VERIFIED BY THE CONTRACTOR PRIOR TO FABRICATION. CONTRACTOR SHALL NOTIFY THE ENGINEER OF ANY DISCREPANCIES.
- SHOULD ANY OF THE DETAILED INSTRUCTIONS SHOWN ON THE PLANS CONFLICT WITH THE GENERAL STRUCTURAL NOTES. THE SPECIFICATIONS, OR WITH EACH OTHER. THE STRICTEST PROVISION SHALL GOVERN.
- THE LATEST REVISION OF THE FOLLOWING CODES AND STANDARDS SHALL BE OBSERVED FOR ALL PROJECT RELATED ACTIVITIES:

OKLAHOMA DEPT. OF TRANSPORTATION 2019 STANDARD SPECIFICATION FOR HIGHWAY CONSTRUCTION (ODOT 2019) ASCE 7-16 UNLESS NOTED OTHERWISE INTERNATIONAL BUILDING CODE-2018 ACI 318-19 AND ACI 315R-18 AWS D1.1-2020 AND AWS D1.4-2018 AISC SPECIFICATION FOR STRUCTURAL STEEL BUILDINGS 360-16 AISC CODE OF STANDARD PRACTICE 303-16 SPECIFICATIONS FOR STRUCTURAL JOINTS USING HIGH-STRENGTH BOLTS-2014

- CONTRACTOR SHALL NOTIFY THE USCG OF MARINE ACTIVITIES IN ACCORDANCE WITH USCG REGULATIONS.
- CONTRACTOR TO DEVELOP AND SUBMIT A STORM WATER POLLUTION PREVENTION PLAN TO OWNER FOR REVIEW AND APPROVAL IN ACCORDANCE WITH EPA REGULATIONS.
- CONTRACTOR SHALL BE RESPONSIBLE FOR THE COST ASSOCIATED WITH ALL MATERIAL, FABRICATION, AND TESTING REQUIRED IN THE PROJECT DOCUMENTS, UNLESS NOTED OTHERWISE
- SURVEY MONUMENTS BASED ON NGS OKLAHOMA STATE PLANE COORDINATE SYSTEM NAD83 (2011), LAMBERT PROJECTION NORTH ZONE.

STRUCTURAL STEEL

- ALL STRUCTURAL STEEL AND ASSOCIATED FABRICATION SHALL CONFORM WITH THE LATEST AISC EDITION MANUAL OF STEEL CONSTRUCTION FOR FABRICATION AND ERECTION OF STRUCTURAL STEEL
- ALL STRUCTURAL STEEL SHALL CONFORM TO ODOT 2019 SECTION 506.
- ALL STEEL WIDE FLANGES AND WT SECTIONS SHALL MEET ASTM A992; STEEL HP AND CHANNELS SHALL MEET ASTM A572 GRADE 50; STEEL ANGLES SHALL MEET ASTM A572 GRADE 50; STEEL PIPE (12" DIAMETER OR LESS) SHALL MEET ASTM A53 GRADE B; AND STEEL PIPE (EXCLUDING ROLLED MONOPILES) (GREATER THAN 12" DIAMETER) SHALL MEET ASTM A252 GRADE 3, UNLESS NOTED OTHERWISE, ALL STEEL PLATE SHALL MEET ASTM A572 GRADE 50
- ALL CONNECTIONS SHALL BE FULL PENETRATION WELDS AND DEVELOP FULL

CAPACITY OF MEMBERS UNLESS OTHERWISE NOTED.

- ALL WELDS SHALL BE PERFORMED IN ACCORDANCE WITH AWS D1.5-2020 LATEST EDITIONS, AND SHALL BE PERFORMED BY AWS QUALIFIED WELDERS. WELDING ELECTRODES TO BE E70XX.
- ALL STRUCTURAL BOLTS SHALL BE TYPE 1 AND HOT DIPPED GALVANIZED, UNLESS OTHERWISE NOTED.
- ALL STRUCTURAL WELDS ARE SUBJECT TO NON-DESTRUCTIVE EXAMINATION BY ULTRASONIC TESTING (UT). EXAMINATION SHALL BE ACCOMPLISHED BY SELECTING SAMPLE GROUPS OF WELDS DURING VARIOUS STAGES OF FABRICATION. FIVE PERCENT (5%) OF THE WELDS WITHIN THE DEFINED SAMPLE GROUP SHALL BE TESTED. IF NO WELDS ARE PROVEN TO BE DEFECTIVE IN THE OPINION OF THE OWNER'S REPRESENTATIVE, NO FURTHER TESTING OF THE SAMPLE GROUP SHALL BE REQUIRED. IF TEN PERCENT (10%) OR MORE OF THE WELDS TESTED ARE PROVEN DEFECTIVE, THE NUMBER OF WELDS TO BE TESTED SHALL BE INCREASED FROM 5 TO 10 PERCENT (10%) OF THE SAMPLE GROUP. IF MORE THAN 10 PERCENT (10%) OF THE WELDS TO THIS TIME ARE PROVEN DEFECTIVE IN THE OPINION OF THE OWNER'S REPRESENTATIVE, THEN ALL OF THE WELDS IN THE SAMPLE GROUP SHALL BE
- OBTAIN APPROVAL OF ENGINEER PRIOR TO CUTTING AN OPENING IN ANY

COATING

- COATING SHALL CONFORM TO ODOT 2019 SECTION 730.02(B).
- ALL STEEL SHALL BE SURFACE BLASTED (NEAR WHITE) IN ACCORDANCE WITH THE LATEST SSPC SPECIFICATIONS AND COATED PER SPECIFICATIONS UNLESS NOTED OTHERWISE. AFTER ERECTION, CONTRACTOR SHALL TOUCH-UP ALL DAMAGED COATING AREAS DUE TO HANDLING TO PROVIDE A FULLY COATED FINISHED PRODUCT
- ALL FIELD WELDS ARE TO BE COATED IN ACCORDANCE WITH COATING MANUFACTURE'S RECOMMENDATIONS AS APPROVED BY ENGINEER.
- ALL PILES AND FRAMING MEMBERS SHALL BE COATED WITH A MINIMUM OF SIXTEEN (16) MILS DFT OF AN APPROVED COATING SYSTEM.
- TO MINIMIZE FIELD WELDING POTENTIAL CORROSION AND POSSIBLE DAMAGE TO THE COATING, CONTRACTOR SHALL COORDINATE WELDING OF CONDUIT SUPPORTS TO STRUCTURAL MEMBERS TO THE MAXIMUM EXTENT POSSIBLE PRIOR TO SURFACE TREATMENT. WHERE PRE-INSTALLED SUPPORTS CAN NOT BE ACCOMMODATED. FIELD WELDING TO STRUCTURAL MEMBERS WILL BE ALLOWED WITH THE SAME SURFACE TREATMENT APPLIED. TREATMENT SHALL BE APPLIED OVER THE ENTIRE WELD AREA.

CONCRETE

- CONCRETE COMPRESSIVE STRENGTH: ALL CONCRETE = 5,000 PSI AT TWENTY-EIGHT (28) DAYS, UNLESS OTHERWISE NOTED, CONCRETE SHALL CONFORM WITH THE "BUILDING CODE REQUIREMENTS FOR REINFORCING CONCRETE", ACI 318-19. CEMENT SHALL BE TYPE II OR IL AND
- CONCRETE WATER/CEMENT RATIO SHALL BE A MAXIMUM OF 0.40.
- CURING CONCRETE SHALL BE KEPT IN MOIST CONDITION FOR AT LEAST SEVEN (7) DAYS AFTER PLACEMENT
- TESTING AND SAMPLING SHALL BE IN ACCORDANCE WITH ODOT SECTION
- CONCRETE FOR STRUCTURES SHALL BE PLACED MONOLITHICALLY, UNLESS
- ALL CONCRETE SHALL BE THOROUGHLY COMPACTED BY MECHANICALLY VIBRATING OR HAND POUNDING. AND SHALL BE THOROUGHLY WORKED AROUND THE REINFORCEMENT AND INTO ALL CORNERS OF THE FORMS.

- ALL STEEL PILING SHALL BE ASTM A709 GR. 50, UNLESS OTHERWISE NOTED. NO LAP WELD OR SPIRAL WELD PIPE WILL BE ALLOWED.
- ALL SPLICES SHALL BE MADE WITH COMPLETE FULL PENETRATION WELDS DEVELOPING THE FULL STRENGTH OF THE SECTION.
- ALL PILES SHALL BE COATED WITH A MINIMUM OF SIXTEEN (16) MILS OF AN APPROVED COATING SYSTEM FROM THE TOP OF THE PILE FOR THE LENGTH NOTED IN THE PILE SCHEDULE.
- THE FIELD SPLICE WELDS FOR ALL OF THE MONOPILES SHALL BE TESTED BY A THIRD PARTY INSPECTION COMPANY APPROVED BY THE ENGINEER

PILE INSTALLATION

- 1. PILE INSTALLATION SHALL CONFORM TO ODOT 2019 SECTION 516.
- ALL PILES SHALL BE INSTALLED TO THEIR ENTIRE LENGTH TO THE DESIGN "TIP OF PILE" ELEVATIONS INDICATED ON THE DRAWINGS.
- THE LENGTH OF THE PILE SHOWN ON THE DRAWINGS IS THE TRUE LENGTH MEASURED ALONG THE CENTERLINE AXIS OF THE PILE AND IS THE LENGTH REQUIRED AFTER THE PILE IS DRIVEN AND CUTOFF (IF NECESSARY) IS ACCOMPLISHED.

CONTRACTOR WILL BE RESPONSIBLE FOR PROVIDING PILES OF SUFFICIENT LENGTH TO ACCOUNT FOR THE ADDED LENGTH REQUIRED FOR THE HAMMER IN USE AND FOR CUTOFF SUCH THAT THE FINAL, DRIVEN, CUTOFF PILE IS THE

LENGTH SHOWN ON THE DRAWINGS.

SHOP DRAWINGS.

SHOP DRAWINGS MUST BE PROVIDED AND REVIEWED BY ENGINEER PRIOR TO

35257(07) 0200 BRIDGE	ITEMS	PAY QUANTITIES - BRIDGE		
ITEM NO.		BID ITEM DESCRIPTION	UNIT	QUANTITIY
509(A)	0210	CLASS AA CONCRETE	C.Y.	920
514(A)	5300	LAMINATED FENDER (2) EA.	26
514(O)	6600	MONOPILE MOORING STRUCTURE (1)(3) L.F.	2120
619(B)	6308	REMOVAL OF BRIDGE ITEM (4) EA.	7

35257(07) 0600 STAKII	NG	PAY QUANTITIES- STAKING		
ITEM NO.		BID ITEM DESCRIPTION	UNIT	QUANTITIY
642(B)	3300	CONSTRUCTION STAKING LEVEL II	L.S.	1

35257 0640		RUCTION	PAY QUANTITIES- CONSTRUCTION		
	ITEM	I NO.	BID ITEM DESCRIPTION	UNIT	QUANTITIY
6-	41	2100	MOBILIZATION	L.S.	1

PAY ITEM NOTES

- LINEAR FOOT COST OF MONOPILE TO INCLUDE BUT NOT LIMITED TO PILES. STRUCTURAL STEEL, STEEL COATING, MUCK AND ROCK EXCAVATION, BOLLARDS, MOORING RAILS, AND ANY OTHER INCIDENTALS RELATED TO THE FABRICATION AND INSTALLATION OF MONOPILES.
- EACH FENDER ESTIMATE SHALL INCLUDE EIGHT (8) WELD ON MOUNTS AND TWO (2) STRAP MOUNTS
- ESTIMATED QUANTITIES SHALL INCLUDE ALL STEEL, RAILS, AND INSTALLATION. ESTIMATE SHALL INCLUDE COATING AS INDICATED ON NOTES AND DRAWINGS
- 4. ALL ITEMS REMOVED TO BECOME PROPERTY OF THE CONTRACTOR


	/ MUSKOGEE		E HIGHWAY MKARNS STATE JOB NO. 35257(07) SHEET NO. AV
SQUAD	UAD		PAY ITEM NOTES
APPROVED	RRM	9-22	PAY QUANTITIES &
CHECKED	EMG	9-22	
DRAWN	MEW	9-22	GENERAL NOTES,
DESIGN	EMG	9-22	OKLAHOMA DEPARTMENT OF TRANSPORTATION

OKLAHOMA DEPARTMENT OF TRANSPORTATION

PRELIMINARY

PLANS

03/24/2023

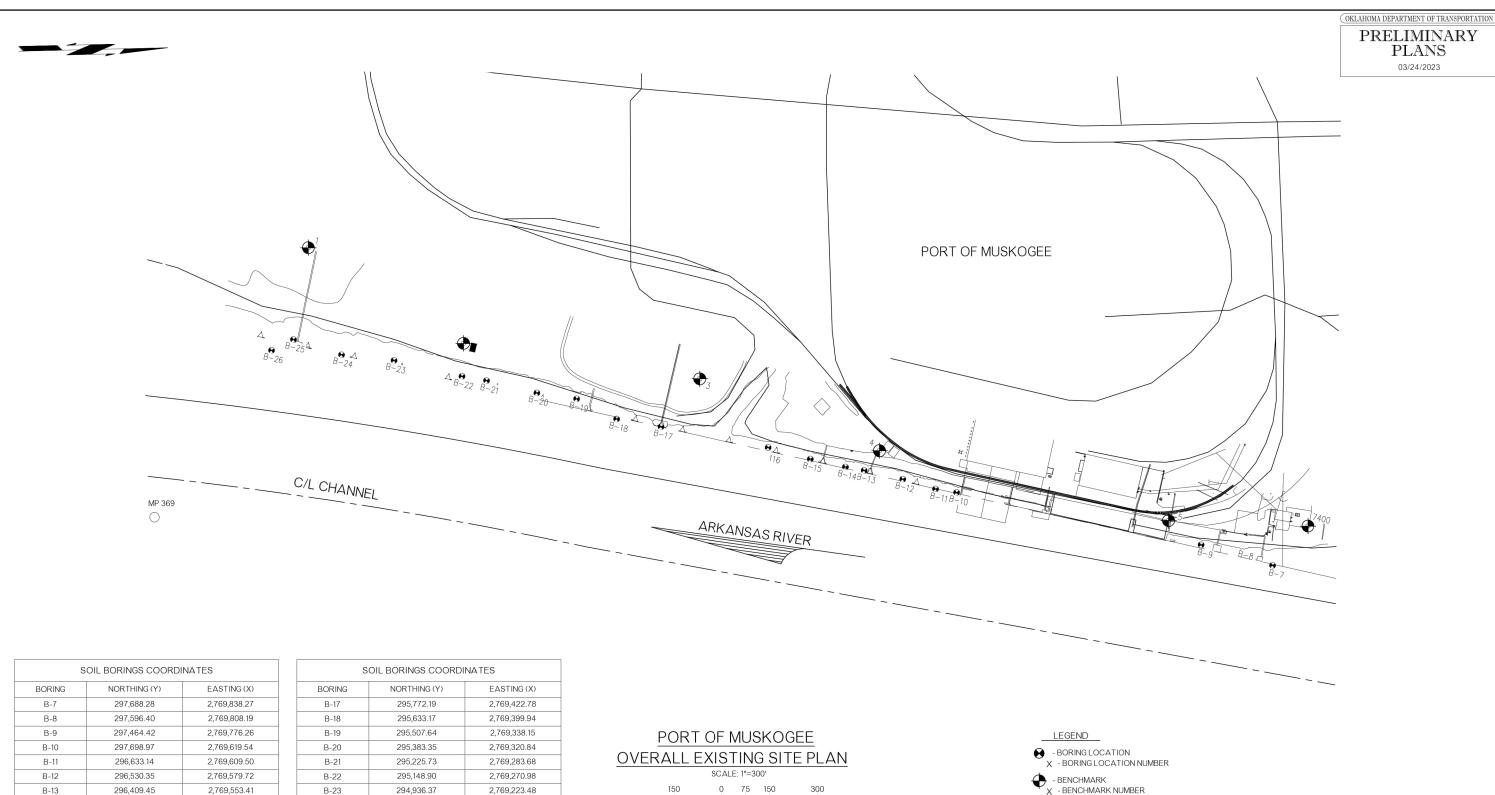

B-14

B-15

B-16

SOIL COORDINATES ARE REFERENCED TO NGS OKLAHOMA STATE PLANE COORDINATE SYSTEM, NAD83 (2011), LAMBERT PROJECTION NORTH ZONE.

2. FOR SOIL BORING INFORMATION SEE SHEET V016 to V018.

296,350.90

296,241.00

296,108.93

2,769,543.17

2,769,519.52

2,769,484.62

B-24

B-25

B-26

294,772.05

294,621.46

294,553.23

2,769,207.28

2,769,161.02


2,769,195.56


X - BENCHMARK NUMBER

OKLAHOMA DEPARTMENT OF TRANSPORTATION DRAWN MEW 9-22 PORT OF MUSKOGEE OVERALL EXISTING CHECKED EMG 9-22 APPROVED RRM 9-22 SITE PLAN SQUAD

PLANS 03/24/2023

COUNTY MUSKOGEE HIGHWAY MKARNS STATE JOB NO. 35257(07) SHEET NO. V001 Wednesday, March 22, 2023 4:59:46 PM

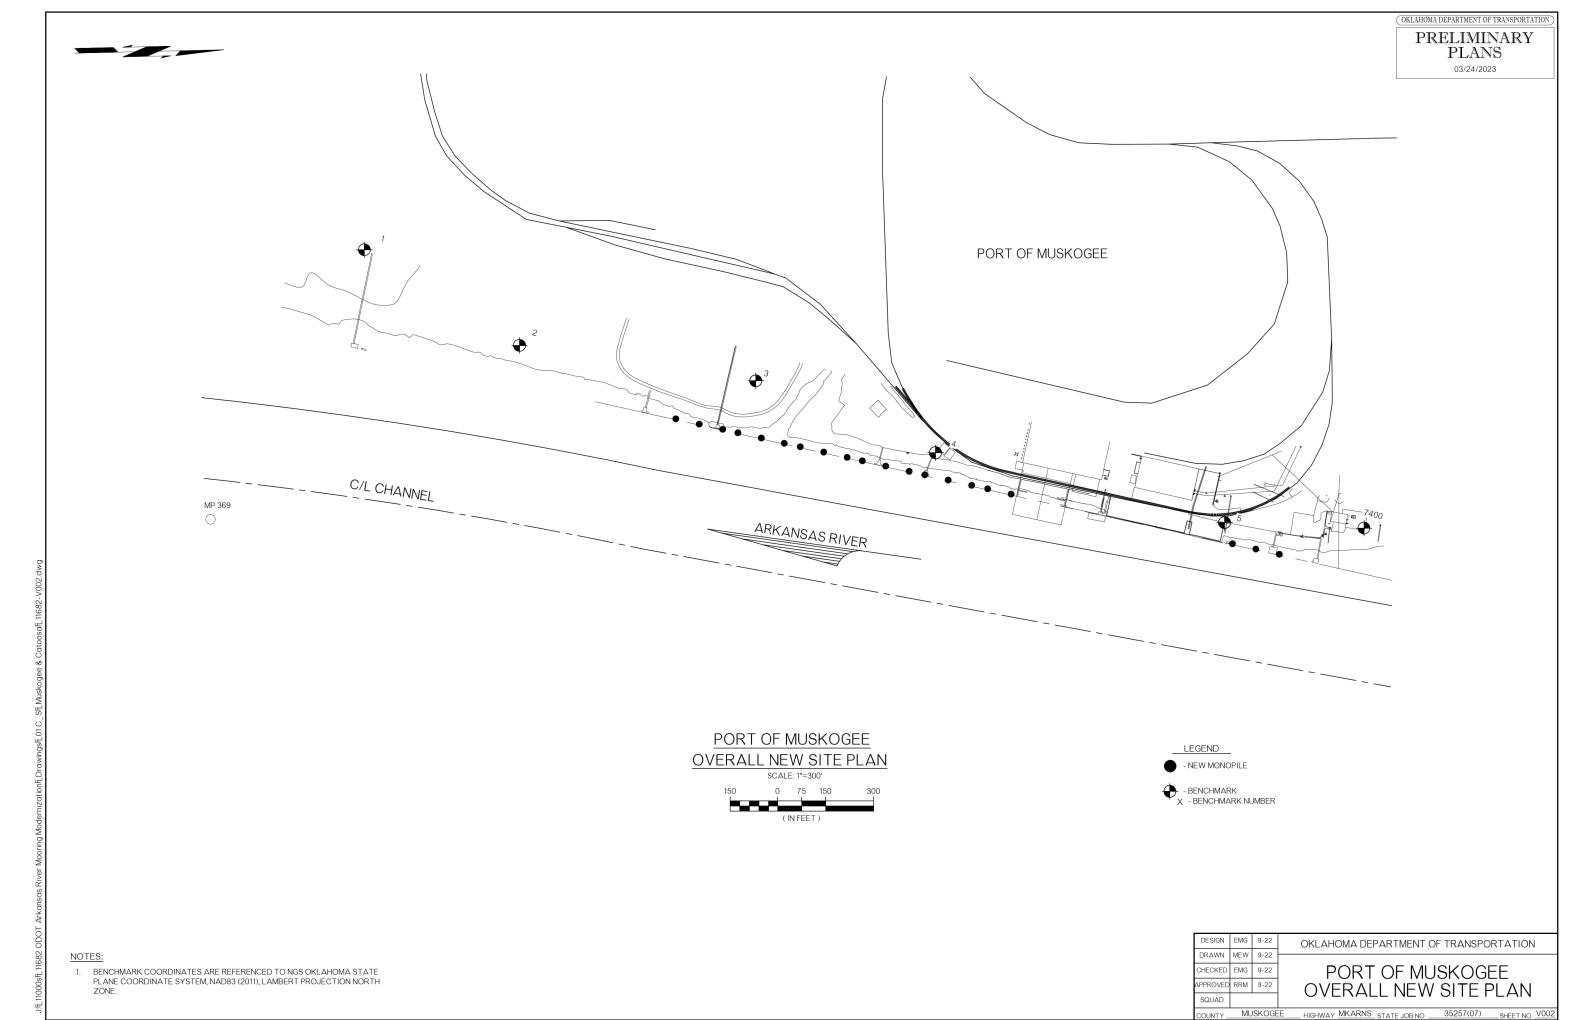

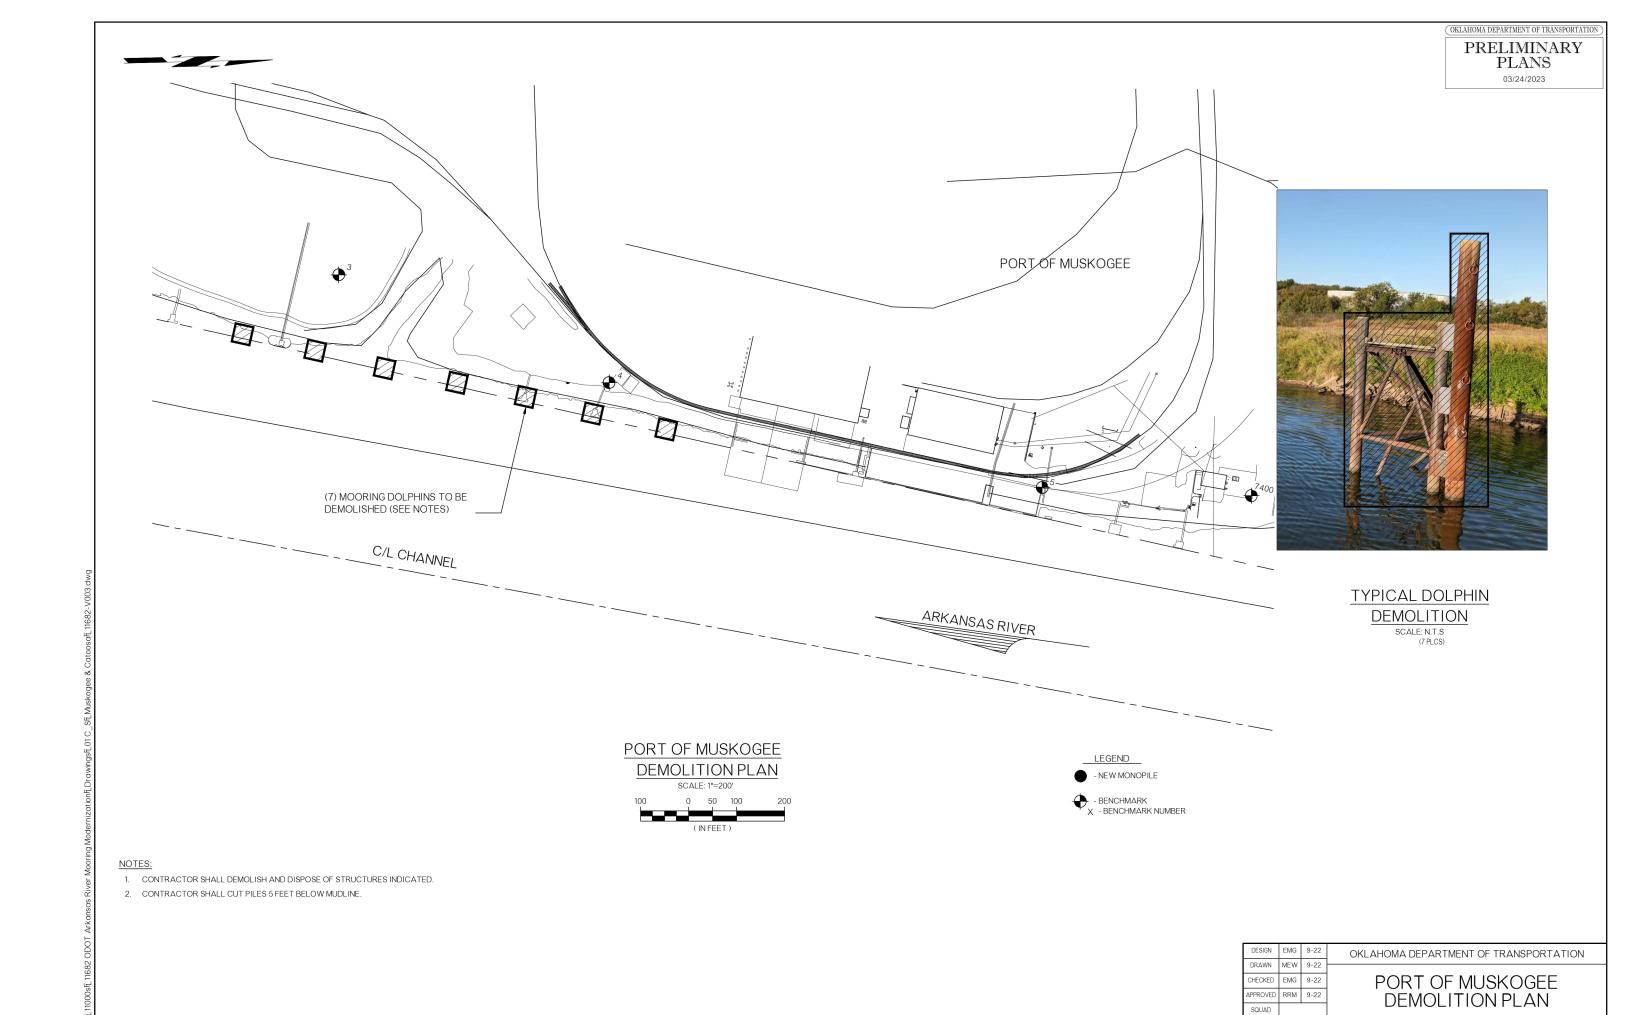

COUNTY MUSKOGEE HIGHWAY MKARNS STATE JOB NO. 35257(07) SHEET NO. V003



PARTIAL PILE PLAN

			PILE SCHEDU	JLE		
PILE DESIGNATION	PILE SIZE	PILE TYPE	CUT OFF EL.	TIP EL.	APPROX. COMPETENT BEDROCK EL.	COATING LENGTH
P1	60" DIA. x VARIES	STEEL PILE	530.00'	445.00'	467.50'	ENTIRE
P2	60" DIA. x VARIES	STEEL PILE	530.00'	445.00'	467.30'	ENTIRE
P3	60" DIA. x VARIES	STEEL PILE	530.00'	445.00'	467.30'	ENTIRE
P4	60" DIA. x VARIES	STEEL PILE	530.00'	445.00'	467.60'	ENTIRE
P5	60" DIA. x VARIES	STEEL PILE	530.00'	445.00'	468.10'	ENTIRE
P6	60" DIA. x VARIES	STEEL PILE	530.00'	445.00'	468.60'	ENTIRE
P7	60" DIA. x VARIES	STEEL PILE	530.00'	445.00'	469.00'	ENTIRE
P8	60" DIA. x VARIES	STEEL PILE	530.00'	445.00'	469.50'	ENTIRE
P9	60" DIA. x VARIES	STEEL PILE	530.00'	445.00'	469.00'	ENTIRE
P10	60" DIA. x VARIES	STEEL PILE	530.00'	445.00'	468.50'	ENTIRE
P11	60" DIA. x VARIES	STEEL PILE	530.00'	445.00'	468.30'	ENTIRE
P12	60" DIA. x VARIES	STEEL PILE	530.00'	445.00'	468.10'	ENTIRE
P13	60" DIA. x VARIES	STEEL PILE	530.00'	445.00'	468.60'	ENTIRE
P14	60" DIA. x VARIES	STEEL PILE	530.00'	445.00'	468.70'	ENTIRE
P15	60" DIA. x VARIES	STEEL PILE	530.00'	445.00'	468.70'	ENTIRE
P16	60" DIA. x VARIES	STEEL PILE	530.00'	445.00'	471.20'	ENTIRE
P17	60" DIA. x VARIES	STEEL PILE	530.00'	445.00'	469.20'	ENTIRE
P18	60" DIA. x VARIES	STEEL PILE	530.00'	445.00'	471.40'	ENTIRE
P19	60" DIA. x VARIES	STEEL PILE	530.00'	445.00'	471.40'	ENTIRE
P20	60" DIA. x VARIES	STEEL PILE	530.00'	445.00'	470.00'	ENTIRE

17	60" DIA. X VARIES	STEEL PILE	530.00	445.00	469.20	ENTIRE
P18	60" DIA. x VARIES	STEEL PILE	530.00'	445.00'	471.40'	ENTIRE
P19	60" DIA. x VARIES	STEEL PILE	530.00'	445.00'	471.40'	ENTIRE
P20	60" DIA. x VARIES	STEEL PILE	530.00'	445.00'	470.00'	ENTIRE
						'
SHEETS V012 &	V014 FOR PILE DETAILS					

__LEGEND

- NEW MONOPILE


- BENCHMARK X - BENCHMARK NUMBER

OKLAHOMA DEPARTMENT OF TRANSPORTATION PRELIMINARY PLANS 03/24/2023 CL. PILES FENDERLINE FENDERLINE 710'-0" 75'-0" 75'-0" P18 ARKANSAS RIVER PORT OF MUSKOGEE __LEGEND__ PARTIAL PILE PLAN - NEW MONOPILE - BENCHMARK X - BENCHMARK NUMBER NOTE: FOR PILE SCHEDULE SEE SHEET V008.

> OKLAHOMA DEPARTMENT OF TRANSPORTATION DRAWN MEW 9-22 CHECKED EMG 9-22 PORT OF MUSKOGEE PARTIAL PILE PLAN APPROVED RRM 9-22

SQUAD

COUNTY MUSKOGEE HIGHWAY MKARNS STATE JOB NO. 35257(07) SHEET NO. V005 Wednesday, March 22, 2023 5:00:24 PM

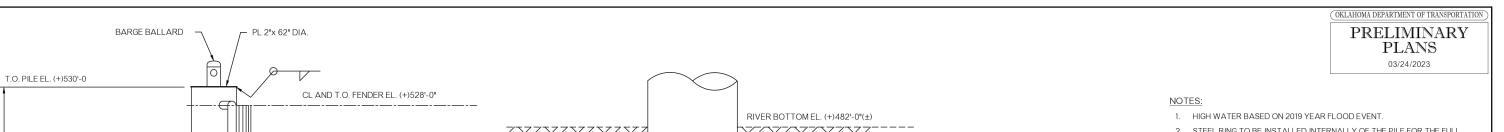

CL EL. (+)468'-0"

CL EL. (+)462'-0"

CL EL. (+)458'-0"

CL EL. (+)452'-0"

CL EL. (+)448'-0"

TIP EL. (+)445'-0"


B.O. ROCK SOCKET EL. (+)444'-6"

BEDROCK EL. (+)468'-0"(±)


T.O.C. EL. (+)478'-0"


STEEL RING (SEE DET. THIS SHT.)

- 2. STEEL RING TO BE INSTALLED INTERNALLY OF THE PILE FOR THE FULL EXTEND OF THE CONCRETE.
- 3. VOID BETWEEN PILE AND ROCK TO BE FILLED WITH CONCRETE TO THE TOP OF THE BEDROCK AS SHOWN ON DRAWING.

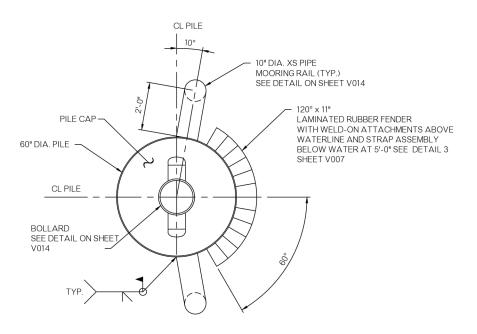

DOLPHIN PLAN SCALE: 1/2" 1'-0"

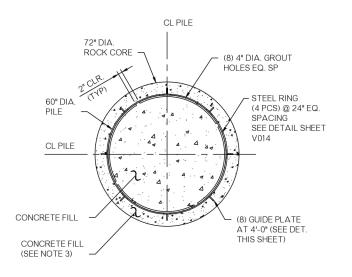

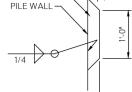

ROCK SOCKET PLAN

PILE GUIDE PLATE SCALE: 1/2" = 1'-0"

SCALE: 1" = 1'-0"

PORT OF MUSKOGEE MONOPILE ELEVATION SCALE: 3/16" = 1'-0"

CL EL. (+)522'-10"

CL EL. (+)513'-4"

CL EL. (+)503'-10"

CL EL. (+)495'-4"

CL EL. (+)491'-4"

LOW WATER EL. (+)488'-6"

B.O. FENDER EL. (+)484'-0" RIVER BOTTOM EL. (+)482'-0" (±)

BEDROCK EL. (+)468'-0"(±)

ROCK SOCKET

(SEE DET. THIS SHT.)

CONCRETE DETAIL (SEE DET. THIS SHT.)

TIP EL. (+)445'-0"

HIGH WATER EL. (+)517'-6"

(20 REQUIRED)

MONOPILE CONCRETE DETAIL

SCALE: 3/8" = 1'-0" (20 REQUIRED)

OKLAHOMA DEPARTMENT OF TRANSPORTATION PORT OF MUSKOGEE CHECKED FMG 9-22 APPROVED RRM 9-22 MONOPILE ELEVATION, PLANS & DETAILS SQUAD MUSKOGEE _ HIGHWAY MKARNS_ STATE JOB NO. _


SEE DETAIL 1 ON DWG V007


SEE DETAIL 2

ON DWG V007


OKLAHOMA DEPARTMENT OF TRANSPORTATION

PRELIMINARY PLANS 03/24/2023

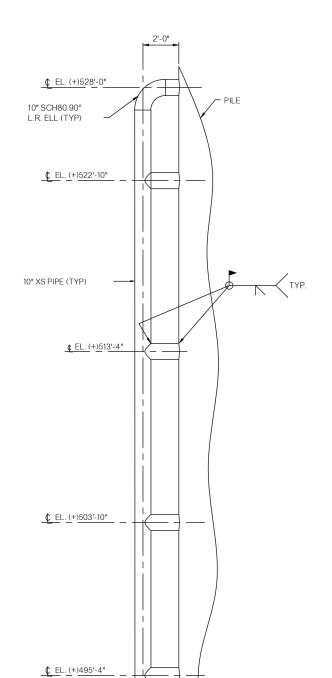


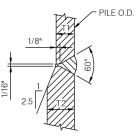


DETAIL 1 SCALE: N.T.S

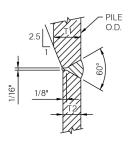


DETAIL 2 SCALE: N.T.S

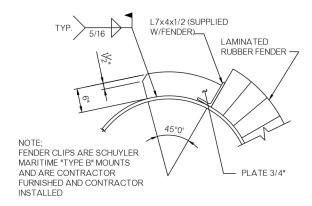


DETAIL 3 SCALE: 1" = 1'-0"

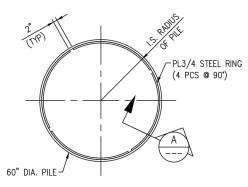

STEEL RING DETAIL SCALE: 1/2" = 1'-0"

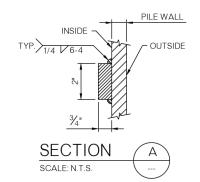

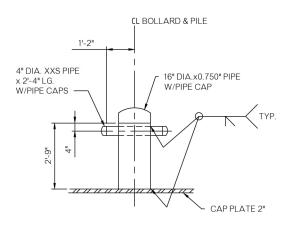

PORT OF MUSKOGEE MOORING RAIL DETAIL SCALE: 3/8" = 1'-0"


MOORING BOLLARD DETAIL

SCALE: 1/2" = 1'-0"

OKLAHOMA DEPARTMENT OF TRANSPORTATION DRAWN MEW 9-22 CHECKED EMG 9-22 PORT OF MUSKOGEE APPROVED RRM 9-22 MONOPILE DETAILS SQUAD HIGHWAY MKARNS STATE JOB NO. 35257(07) SHEET NO. V007 COUNTY MUSKOGEE

¢ EL. (+)491'-4"

PLANS 03/24/2023

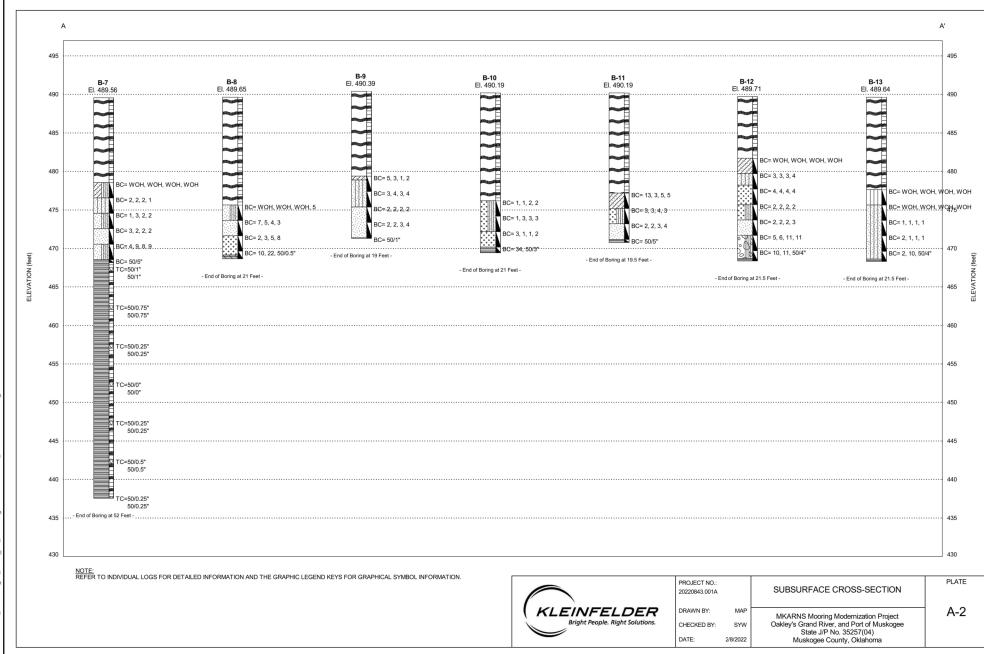

PORT OF MUSKOGEE SOIL BORING INFORMATION

1. DRIVING TIP TO BE INSTALLED AS NEEDED TO PREVENT DAMAGE TO PILE TIP DURING DRIVING.

SAMPLE/SAMPLER TYPE GRAPHICS UNIFIED SOIL CLASSIFICATION SYSTEM (ASTM D 2487) WELL-GRADED GRAVELS, GRAVEL-SAND MIXTURES WITH LITTLE OR NO FINES and GW CLEAN GRAVEL WITH <5% FINES POORLY GRADED GRAVELS, GRAVEL-SAND MIXTURES WITH LITTLE OR NO FINES GP TANDARD PENETRATION SPLIT SPOON SAMPLER tin. (50.8 mm.) outer diameter and 1-3/8 in. (34.9 mm.) inne WELL-GRADED GRAVELS, GRAVEL-SAND MIXTURES WITH LITTLE FINES GW-GM TEXAS CONE PENETRATION WELL-GRADED GRAVELS, GROUND WATER GRAPHICS GW-GC GRAVEL-SAND MIXTURES WITH LITTLE CLAY FINES POORLY GRADED GRAVELS, GRAVEL-SAND MIXTURES WITH LITTLE FINES ▼ WATER LEVEL (level after exploration completion) ▼ WATER LEVEL (additional levels after exploration) POORLY GRADED GRAVELS, GRAVEL-SAND MIXTURES WITH LITTLE CLAY FINES OBSERVED SEEPAGE GP-GC SILTY GRAVELS, GRAVEL-SILT-SAND MIXTURES CLAYEY GRAVELS, GRAVEL-SAND-CLAY MIXTURES Lines separating strata on the logs represent approximate boundaries only. Actual transitions may be gradual or differ from those shown. WITH > 12% FINES No warranty is provided as to the continuity of soil or rock conditions between individual sample locations. CLAYEY GRAVELS, GRAVEL-SAND-CLAY-SILT MIXTURES Logs represent general soil or rock conditions observed at the point of exploration on the date indicated. WELL-GRADED SANDS, SAND-GRAVEL MIXTURES WITH LITTLE OR NO FINES In general, Unified Soil Classification System designations presented on the logs were based on visual classification in the field and were modified where appropriate based on gradation and index property testing. CLEAN SANDS WITH <5% FINES POORLY GRADED SANDS, SAND-GRAVEL MIXTURES WITH LITTLE OR NO FINES Fine grained soils that plot within the hatched area on the Plasticity Chart, and coarse grained soils with between 5% and 12% passing the No 200 sieve require dual USCS symbols, i.e., GW-GM, GP-GM, GW-GC, GP-GC, GC-GM, SW-SM, SP-SM, SW-SC, SP-SC, SC-SM. WELL-GRADED SANDS, SAND-GRAVEL MIXTURES WITH LITTLE FINES If sampler is not able to be driven at least 6 inches then 50/X indicates number of blows required to drive the identified sampler X inches with a 140 pound hammer falling 30 inches. SW-SM WELL-GRADED SANDS, SAND-GRAVEL MIXTURES WITH LITTLE CLAY FINES SANDS WITH 5% TO 12% FINES TCP-Texas Cone Penetrometer: A 3 inch diameter by 2.5 inch long 60 degree conical point driven with a 140 pound hammer dropped 30 inches. SW-SC POORLY GRADED SANDS, SAND-GRAVEL MIXTURES WITH LITTLE FINES SP-SM POORLY GRADED SANDS, SAND-GRAVEL MIXTURES WITH LITTLE CLAY FINES SP-SC SILTY SANDS, SAND-GRAVEL-SILT MIXTURES SANDS WITH > 12% FINES CLAYEY SANDS, SAND-GRAVEL-CLAY MIXTURES CLAYEY SANDS, SAND-SILT-CLAY MIXTURES ML ORGANIC SLITS AND VERY FINE SANDS, SLITY OR CLAYS FINE SANDS, SLITY OR C PROJECT NO.: **GRAPHICS KEY** 20220843.001A **KLEINFELDER** DRAWN BY: A-5 MKARNS Mooring Modernization Project CHECKED BY: SYW Oakley's Grand River, and Port of Muskogee State J/P No. 35257(04)

DESIGN	EMG	9-22	OKLAHOMA DEPARTMENT OF TRANSPORTATION
DRAWN	MEW	9-22	
CHECKED	EMG	9-22	PORT OF MUSKOGEF
APPROVED	RRM	9-22	SOIL BORING INFORMATION

Wednesday, March 22, 2023 5:00:43 PM

SQUAD MUSKOGEE


DATE:

2/8/2022

HIGHWAY MKARNS STATE JOB NO. 35257(07) SHEET NO. VOOS

OKLAHOMA DEPARTMENT OF TRANSPORTATION

PRELIMINARY
PLANS
03/24/2023

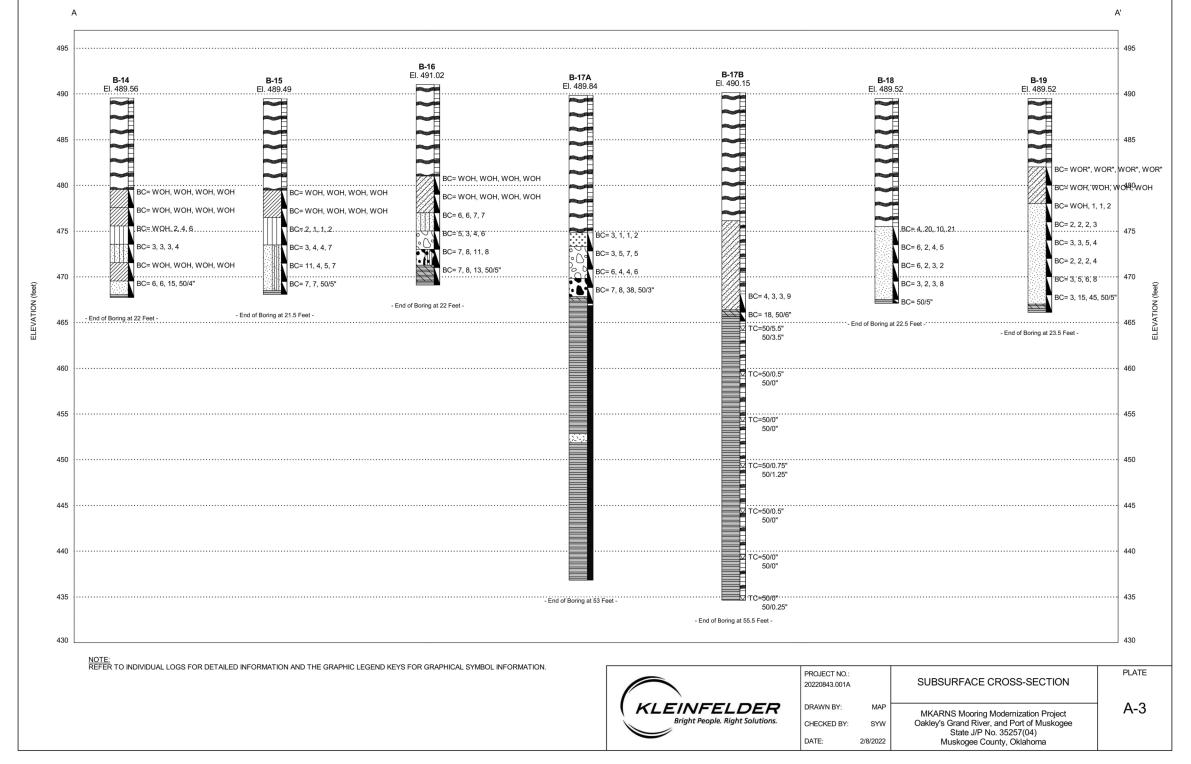


<u>PORT OF MUSKOGEE</u> SOIL BORING INFORMATION NOTES:

DRIVING TIP TO BE INSTALLED AS NEEDED TO PREVENT DAMAGE TO PILE TIP DURING DRIVING.

	DESIGN	EMG	9-22	OKLAHOMA DEPARTMENT OF TRANSPORTATION
- [DRAWN	MEW	9-22	
ı,	5,0,1,1,1		0 22	
	CHECKED	EMG	9-22	PORT OF MUSKOGEE
-	APPROVED	RRM	9-22	SOIL BORING INFORMATION
	SQUAD			OOIL DOMING IN ONWATION
	COUNTY_	ML	JSKOGE	E HIGHWAY MKARNS STATE JOBNO. 35257(07) SHEET NO. V009

OKLAHOMA DEPARTMENT OF TRANSPORTATION

PRELIMINARY
PLANS
03/24/2023

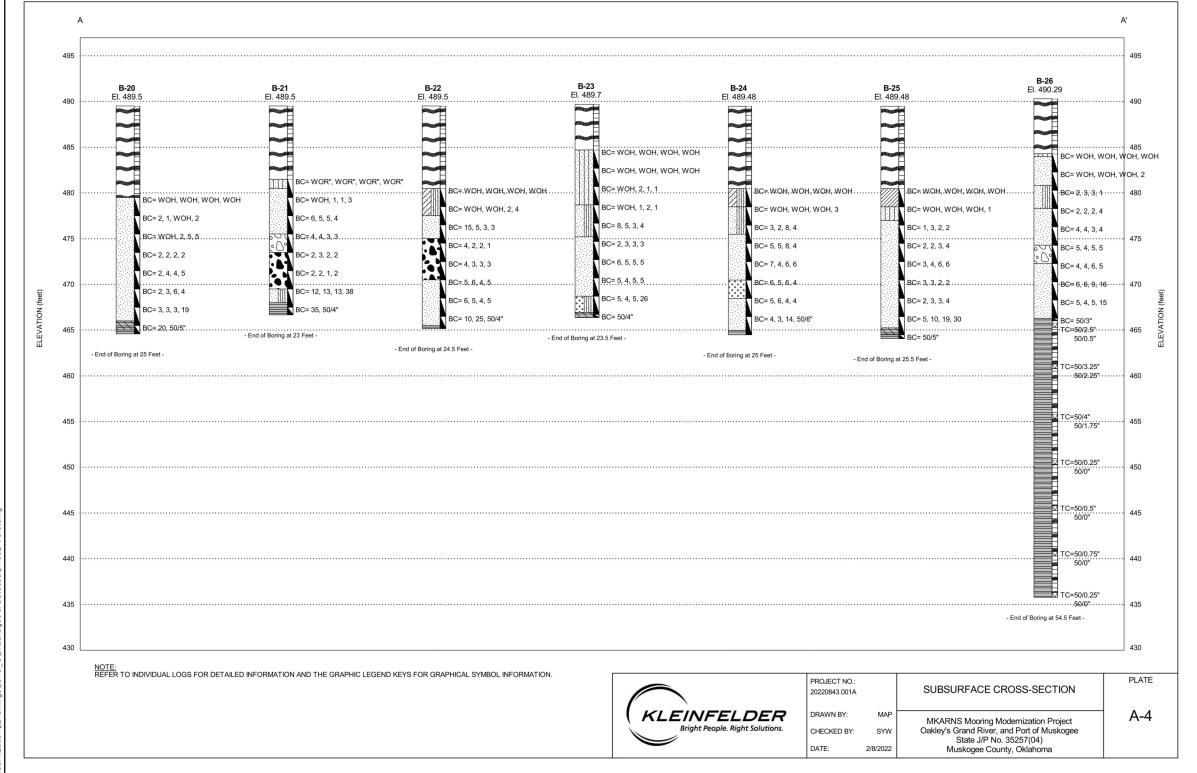

<u>PORT OF MUSKOGEE</u> SOIL BORING INFORMATION NOTES:

DRIVING TIP TO BE INSTALLED AS NEEDED TO PREVENT DAMAGE TO PILE TIP DURING DRIVING.

DESIG	in E	MG	9-22	OKLAHOMA DEPARTMENT OF TRANSPORTATION							
DRAW	/N M	1EW	9-22								
CHECK	ED E	MG	9-22	PORT OF MUSKOGEE							
APPRO\	/ED R	RRM	9-22	SOIL BORING INFORMATION							
SQUA	.D			SOIL BOITING IN ORMATION							
COLINIT		I INA	SKOGE	E LUCINAY MKARNS OTATE LORAGO 35257(07) QUEETAG VO							

OKLAHOMA DEPARTMENT OF TRANSPORTATION

PRELIMINARY PLANS

03/24/2023

LEGEND

- BENCHMARK X - BENCHMARK NUMBER

	BENCHMARK TABLE							
BORING	NORTHING (Y)	EASTING (X)						
4	456468.28	2637163.98						
5	457066.20	2636885.34						
6	457608.26	2636459.05						
7	458163.40	2636022.42						
8	458659.38	2635709.98						
9	459110.34	2635353.99						
10	459571.56	2634991.29						
11	459892.01	2634738.79						
12	459885.08	2635932.83						
13	459291.70	2636202.76						
14	458665.06	2636683.32						
15	458152.12	2637084.84						
16	457606.05	2637515.42						
17	457136.17	2637756.79						
18	456356.51	2638080.28						
7401	460459.75	2635482.81						

PORT OF CATOOSA OVERALL EXISTING SITE PLAN

SCALE: 1"=300"


0 150 300 (IN FEET)

DESIGN	EMG	9-22	OKLAHOMA DEPARTMENT OF TRANSPORTATION	
DRAWN	MEW	9-22	PORT OF CATOOSA	-
CHECKED	EMG	9-22		
APPROVED	RRM	9-22	OVERALL EXISTING	
SQUAD			SITE PLAN	
COUNTY	R	OGERS	HIGHWAY MKARNS STATE JOB NO 35257(07) SHEET NO VO	51

OKLAHOMA DEPARTMENT OF TRANSPORTATION PRELIMINARY PLANS 03/24/2023 LEGEND - NEW MONOPILE - BENCHMARK X - BENCHMARK NUMBER NEW MONOPILE _DOLPHIN (TYP.) NEW MONOPILE DOLPHIN (TYP.) PORT OF CATOOSA OVERALL NEW SITE PLAN OKLAHOMA DEPARTMENT OF TRANSPORTATION DRAWN MEW 9-22 CHECKED EMG 9-22 PORT OF CATOOSA APPROVED RRM 9-22 OVERALL NEW SITE PLAN SQUAD

HIGHWAY MKARNS STATE JOB NO. 35257(07) SHEET NO. V012

OKLAHOMA DEPARTMENT OF TRANSPORTATION PRELIMINARY PLANS 03/24/2023 LEGEND - NEW MONOPILE - BENCHMARK X - BENCHMARK NUMBER NEW MONOPILE DOLPHINS (TYP.) -PORT OF CATOOSA PARTIAL ENLARGED NEW SITE PLAN OKLAHOMA DEPARTMENT OF TRANSPORTATION DRAWN MEW 9-22 PORT OF CATOOSA PARTIAL ENLARGED NEW SITE PLAN CHECKED EMG 9-22
APPROVED RRM 9-22 SQUAD HIGHWAY MKARNS STATE JOB NO. 35257(07) SHEET NO. V013 Wednesday, March 22, 2023 5:01:26 PM

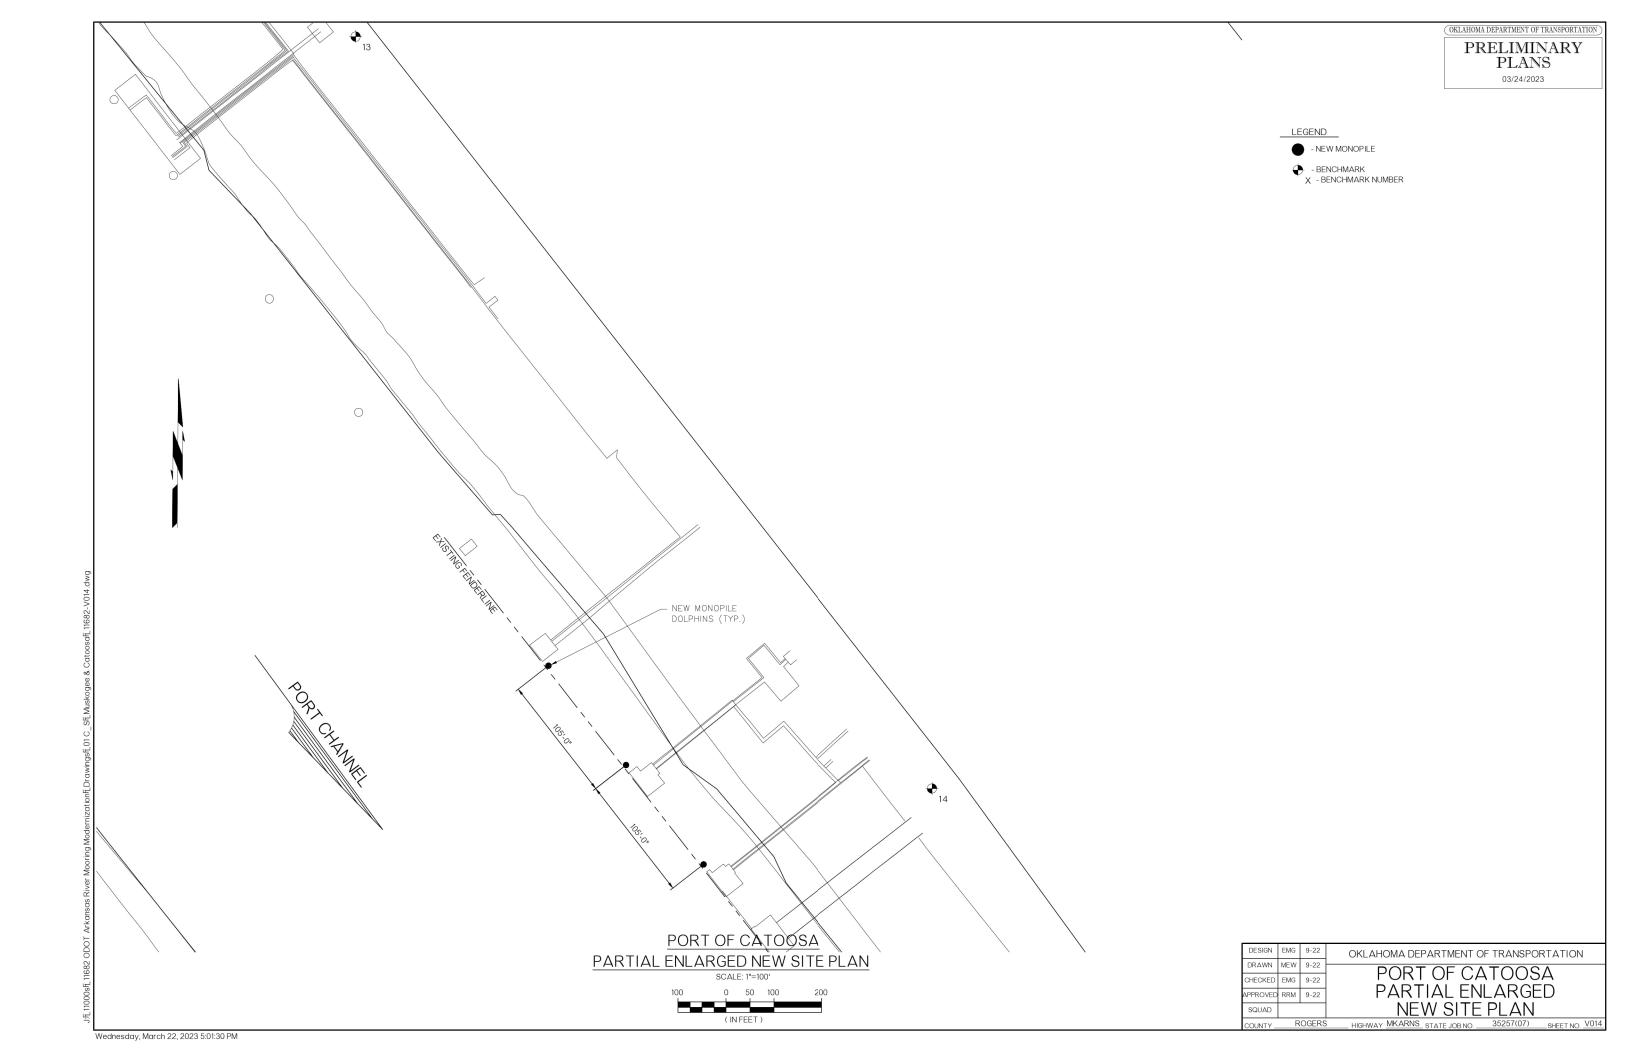

OKLAHOMA DEPARTMENT OF TRANSPORTATION


PRELIMINARY
PLANS

03/24/2023

LEGEND

- NEW MONOPILE

- BENCHMARK X - BENCHMARK NUMBER

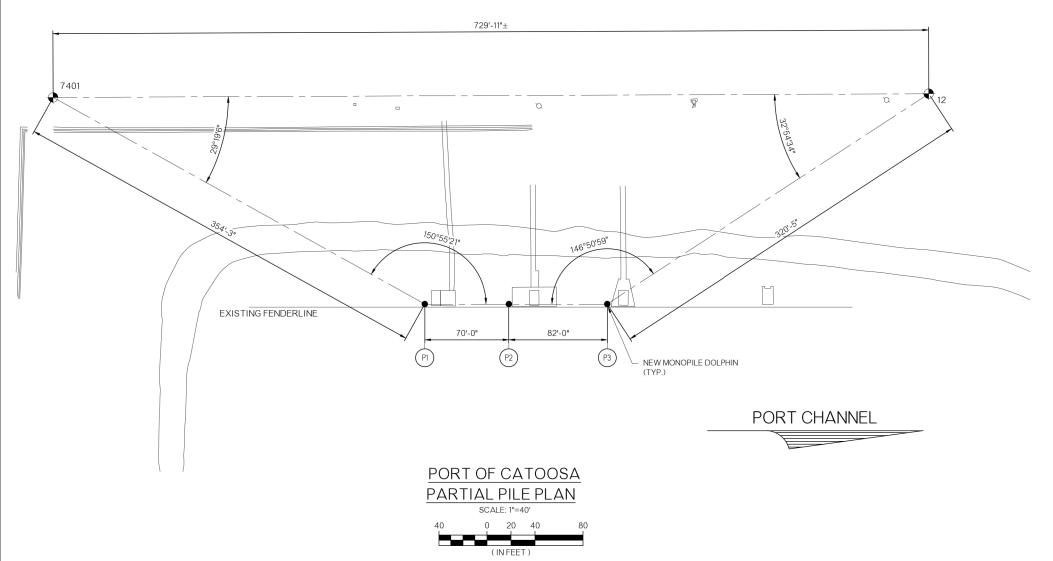

PILE SCHEDULE										
PILE	PILE SIZE	PILE TYPE	CUT OFF EL.	TIP EL.	APPROX. COMPETENT	COATIN G				
DESIGNATION					BEDROCK EL.	LENGTH				
P1	60"DIA. x VARIES	STEEL PILE	572.00'	502.00'	466.90'	ENTIRE				
P2	60"DIA. x VARIES	STEEL PILE	572.00'	502.00'	467.90'	ENTIRE				
P3	60"DIA. x VARIES	STEEL PILE	572.00'	502.00'	466.40'	ENTIRE				
P4	60"DIA. x VARIES	STEEL PILE	572.00'	502.00'	468.20'	ENTIRE				
P5	60"DIA. x VARIES	STEEL PILE	572.00'	502.00'	467.70'	ENTIRE				
P6	60"DIA, x VARIES	STEEL PILE	572.00'	502.00'	470.50'	ENTIRE				

DESIGN	EMG	9-22	OKLAHOMA DEPARTMENT OF TRANSPORTATION
DRAWN	MEW	9-22	PORT OF CATOOSA
CHECKED	EMG	9-22	1 3111 31 3711 3 3 371
APPROVE	RRM	9-22	PARTIAL PILE PLAN
SQUAD			& PILE SCHEDULE
COLINITY	F	OGERS	S LUCLIMAN MKARNS STATE JORNO 35257(07) SUFETING VO15

Wednesday, March 22, 2023 5:01:35 PM

* SEE SHEET V017 & V018 FOR PILE DETAILS

ver Mooring ModernizationFL DrawingsFL01 C_SFLMuskogee & CatoosafL 11682-V015.dv

159°3'52" EXISTING FENDERLINE EXISTING FENDERLINE 105'-0" 105'-0" NEW MONOPILE DOLPHIN (TYP.) EXISTING BREASTING DOLPHIN (TYP.) PORT CHANNEL PORT OF CATOOSA PARTIAL PILE PLAN (IN FEET) NOTE: FOR PILE SCHEDULE SEE SHEET V010.

OKLAHOMA DEPARTMENT OF TRANSPORTATION)

PRELIMINARY
PLANS

03/24/2023

LEGEND

- NEW MONOPILE

- BENCHMARK X - BENCHMARK NUMBER

DESIGN EMG 9-22
DRAWN MEW 9-22
CHECKED EMG 9-22
APPROVED RRM 9-22
SQUAD
COUNTY ROGERS

OKLAHOMA DEPARTMENT OF TRANSPORTATION

PORT OF CATOOSA
PARTIAL PILE PLAN
STATE JOB NO. 35257(07) SHEET NO. V016


Wednesday, March 22, 2023 5:01:40 PM



03/24/2023

NOTES:

- 1. HIGH WATER BASED ON 2019 YEAR FLOOD EVENT.
- 2. STEEL RING TO BE INSTALLED INTERNALLY OF THE PILE FOR THE FULL EXTEND OF THE CONCRETE.
- 3. VOID BETWEEN PILE AND ROCK TO BE FILLED WITH CONCRETE TO THE TOP OF THE BEDROCK AS SHOWN ON DRAWING.

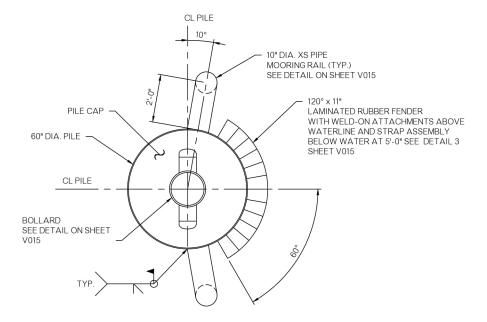

DOLPHIN PLAN SCALE: 1/2" 1'-0"

CL PILE


72" DIA.
ROCK CORE

60" DIA.
PILE

CL PILE

60" DIA.
PILE

CONCRETE FILL

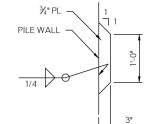

ROCK SOCKET PLAN

SCALE: 1/2" = 1'-0"

PILE GUIDE PLATE

SCALE: 1" = 1'-0"

DESIGN	EMG	9-22	OKLAHOMA DEPARTMENT OF TRANSPORTATION
DRAWN	MEW	9-22	
DRAWN	IVIL VV	9-22	PORT OF CATOOSA
		0. 7	
CHECKED	EMG	9-22	
APPROVED	RRM	9-22	MONOPILE ELEVATION, PLANS
	1313141	0 22	1113113112222217111311,127113
SQUAD			9 DETAIL
SQUAD			A DLIAILS
		00500	MICATELIO 05057(07) 1/017
COUNTY _	R	OGERS	HIGHWAY MKARNS STATE JOB NO. 35257(07) SHEET NO. V017

Wednesday, March 22, 2023 5:01:45 PM

BARGE BALLARD -

SEE DETAIL 1

ON DWG V015

SEE DETAIL 2

ON DWG V015

PORT OF CATOOSA

MONOPILE ELEVATION

SCALE: 3/16" = 1'-0" (6 REQUIRED)

T.O. PILE EL. (+)572'-0

PL 2"x 62" DIA.

CL AND T.O. FENDER EL. (+)569'-10"

T.O.C. EL. (+)525'-0"

STEEL RING

(SEE DET. THIS SHT.)

CL EL. (+)519'-0"

CL EL. (+)513'-0"

CL EL. (+)509'-0"

CL EL. (+)505'-0"

TIP EL. (+)502'-0"

MONOPILE CONCRETE DETAIL

SCALE: 3/8" = 1'-0"

(6 REQUIRED)

B.O. ROCK SOCKET EL. (+)501'-6"

BEDROCK EL. (+)519'-0"(±)

CL EL. (+)560'-4"

CL EL. (+)550'-10"

CL EL. (+)543'-10"

CL EL. (+)535'-10"

CL EL. (+)528'-4"

- ROCK SOCKET (SEE DET. THIS SHT.)

CONCRETE DETAIL

(SEE DET. THIS SHT.)

TIP EL. (+)502'-0"

LOW WATER EL. (+)532'-10"

B.O. FENDER EL. (+)523'-0"

BEDROCK EL. (+)519'-0"(±)


HIGH WATER EL. (+)560'-0"




PILE O.D. ¢ EL. (+)569'-10" 10" SCH80 90° L.R. ELL (TYP) DETAIL SCALE: N.T.S. 10" DIA. XS PIPE (TYP) ¢ EL. (+)560'-4" DETAIL SCALE: N.T.S. ¢ EL. (+)550'-10" -PL3/4 STEEL RING (4 PCS @ 90°) ¢ EL. (+)543'-10" 60" DIA. PILE ✓ STEEL RING DETAIL SCALE: 1/2" = 1'-0" ¢ EL. (+)535'-10" CL BOLLARD & PILE 1'-2" 4" DIA. XXS PIPE 16" DIA.x0.750" PIPE W/PIPE CAP x 2'-4" LG. W/PIPE CAPS <u>**¢**</u> EL. (+)528'-4" - CAP PLATE 2"

MOORING BOLLARD DETAIL

SCALE: 1/2" = 1'-0"

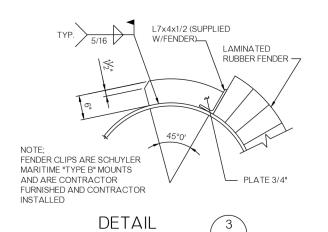

SCALE: 1" = 1'-0"

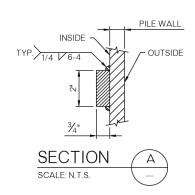

DESIGN	EMG	9-22	OKLAHOMA DEPARTMENT OF TRANSPORTATION
DRAWN	MEW	9-22	
CHECKED	EMG	9-22	PORT OF CATOOSA
APPROVED	RRM	9-22	MONOPII F DETAILS
SQUAD			WONOTILL DETAILS
COUNTY_	Y ROGERS		HIGHWAY MKARNS STATE JOB NO. 35257(07) SHEET NO. V018

PORT OF CATOOSA

MOORING RAIL DETAIL


SCALE: 3/8" = 1'-0"


OKLAHOMA DEPARTMENT OF TRANSPORTATION


PRELIMINARY
PLANS

03/24/2023

03/24/2023

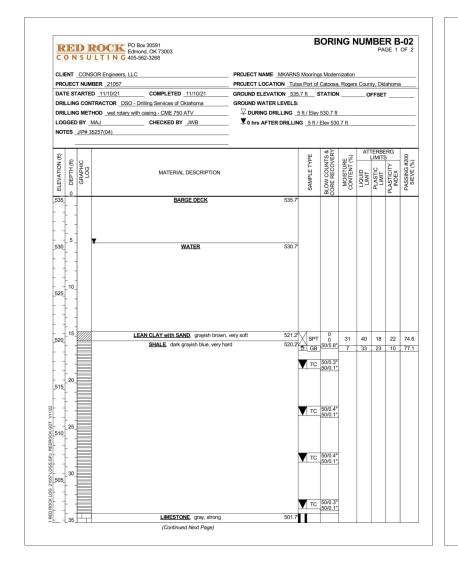

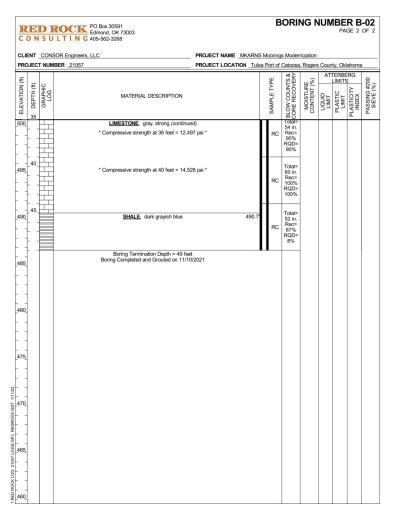

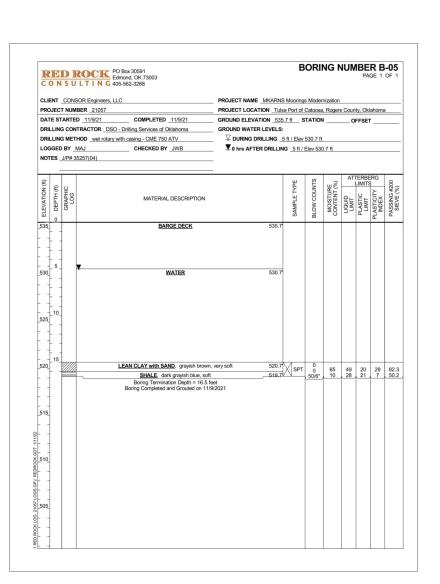

PORT OF CATOOSA SOIL BORING INFORMATION

-				
	DESIGN	EMG	9-22	OKLAHOMA DEPARTMENT OF TRANSPORTATION
١	DRAWN	MEW	9-22	
Ì	CHECKED	EMG	9-22	PORT OF CATOOSA
Į	APPROVED	RRM	9-22	SOIL BORING INFORMATION
Ì	SQUAD			SOIL BOILING IN ORWATION
	COUNTY_	ROGERS		HIGHWAY MKARNS STATE JOB NO. 35257(07) SHEET NO. V019

J:fi 11000sfi 11682 ODOT Arkansas Ri